

NOTES: VERIFY ALL DIMENSIONS IN FIELD PRIOR TO FABRICATION AND CONSTRUCTION. ALL EXISTING CONDITIONS TO REMAIN AS IS UNLESS OTHERWISE NOTED



EXISTING CONDITION

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1 PERSPECTIVE VIEW - EYE LEVEL



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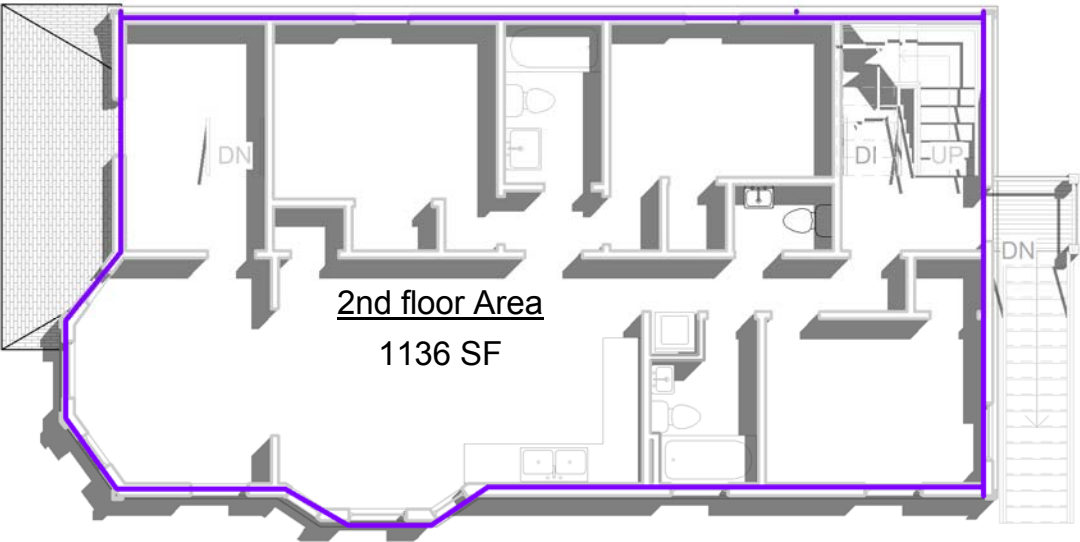
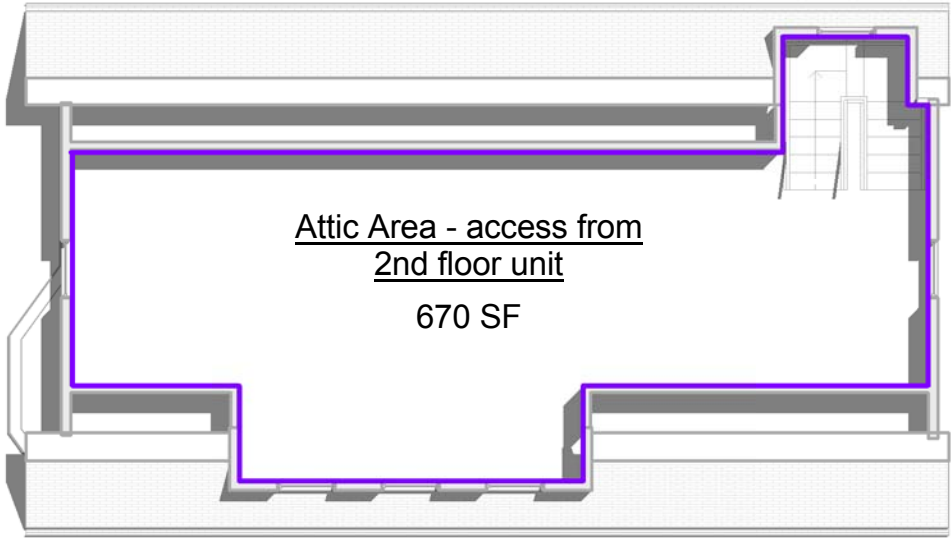
30 FRANKLIN STREET,
SOMERVILLE, MA
TRIPLE DECKER REVIVAL

No.	Description	Date


COVER SHEET

Project number	Project Number	A0
Date	Issue Date	
Drawn by	Author	
Checked by	Checker	
		Scale

NOTES: VERIFY ALL DIMENSIONS IN FIELD PRIOR TO FABRICATION AND CONSTRUCTION. ALL EXISTING CONDITIONS TO REMAIN AS IS UNLESS OTHERWISE NOTED



3 2ND FLOOR
1" = 10'-0"

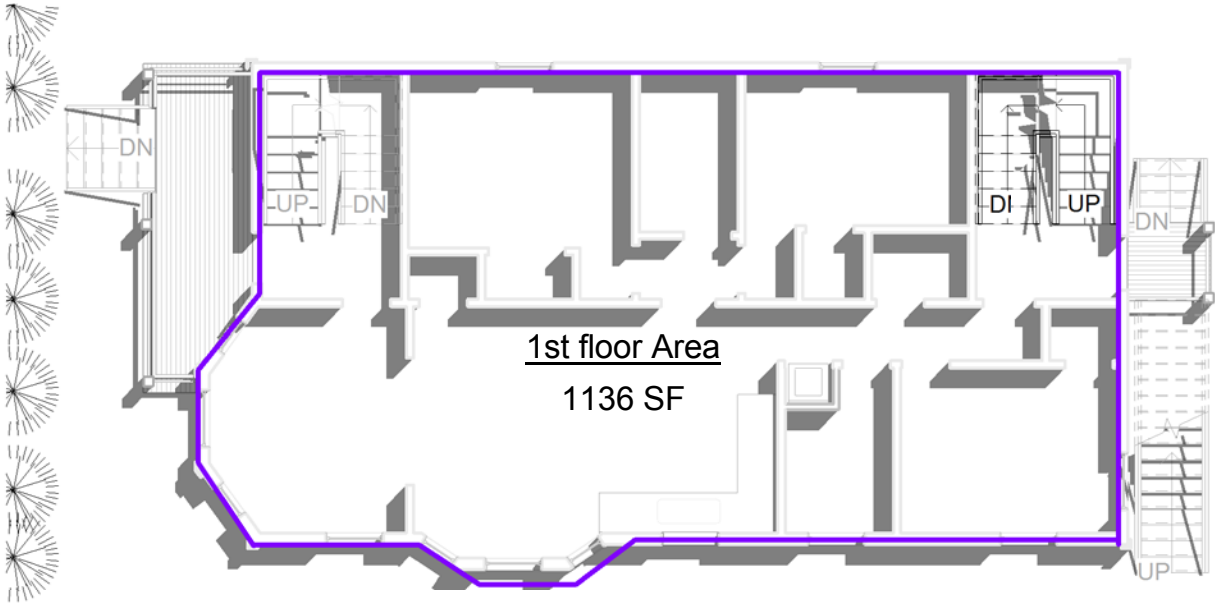

2 1ST FLOOR
1" = 10'-0"

1 ATTIC LEVEL
1" = 10'-0"

TOTAL SITE AREA: 4490 SQ. FEET
TOTAL BUILDING AREA: 2942 SQ. FEET

PROPOSED FLOOR TO AREA RATIO: .65*
*Less than .75 F.A.R.

EXISTING BUILDING AREA: 1490 SF.
PROPOSED ADDITION OF 1452 SF (NOT INCLUDING BASEMENT)



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No.	Description	Date


AREA ANALYSIS PLANS

Project number	Project Number
Date	Issue Date
Drawn by	Author
Checked by	Checker


A0.1

Scale 1" = 10'-0"

NOTES: VERIFY ALL DIMENSIONS IN FIELD PRIOR TO FABRICATION AND CONSTRUCTION. ALL EXISTING CONDITIONS TO REMAIN AS IS UNLESS OTHERWISE NOTED

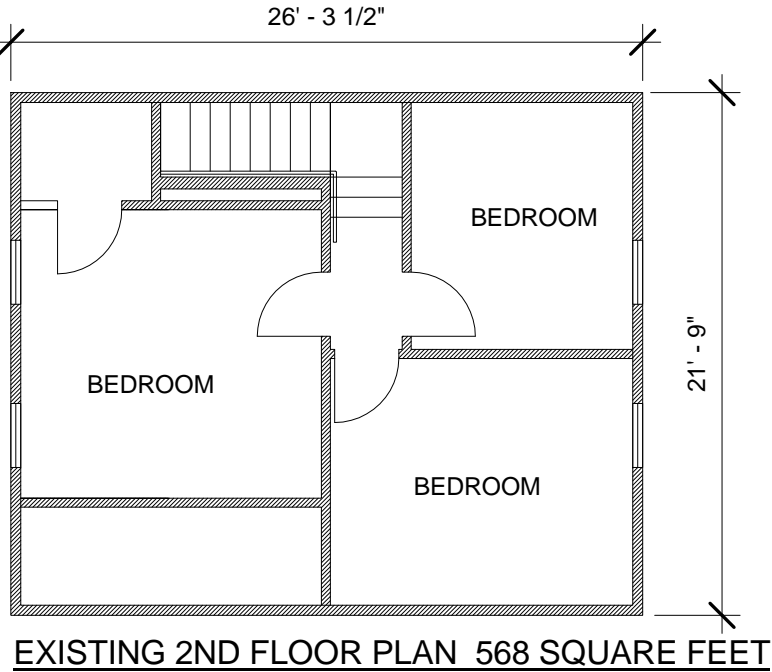

NOTES: THESE PLANS ARE PROVIDED AS REFERENCE ONLY. VERIFY 1490 SQUARE FEET TOTAL EXISTING

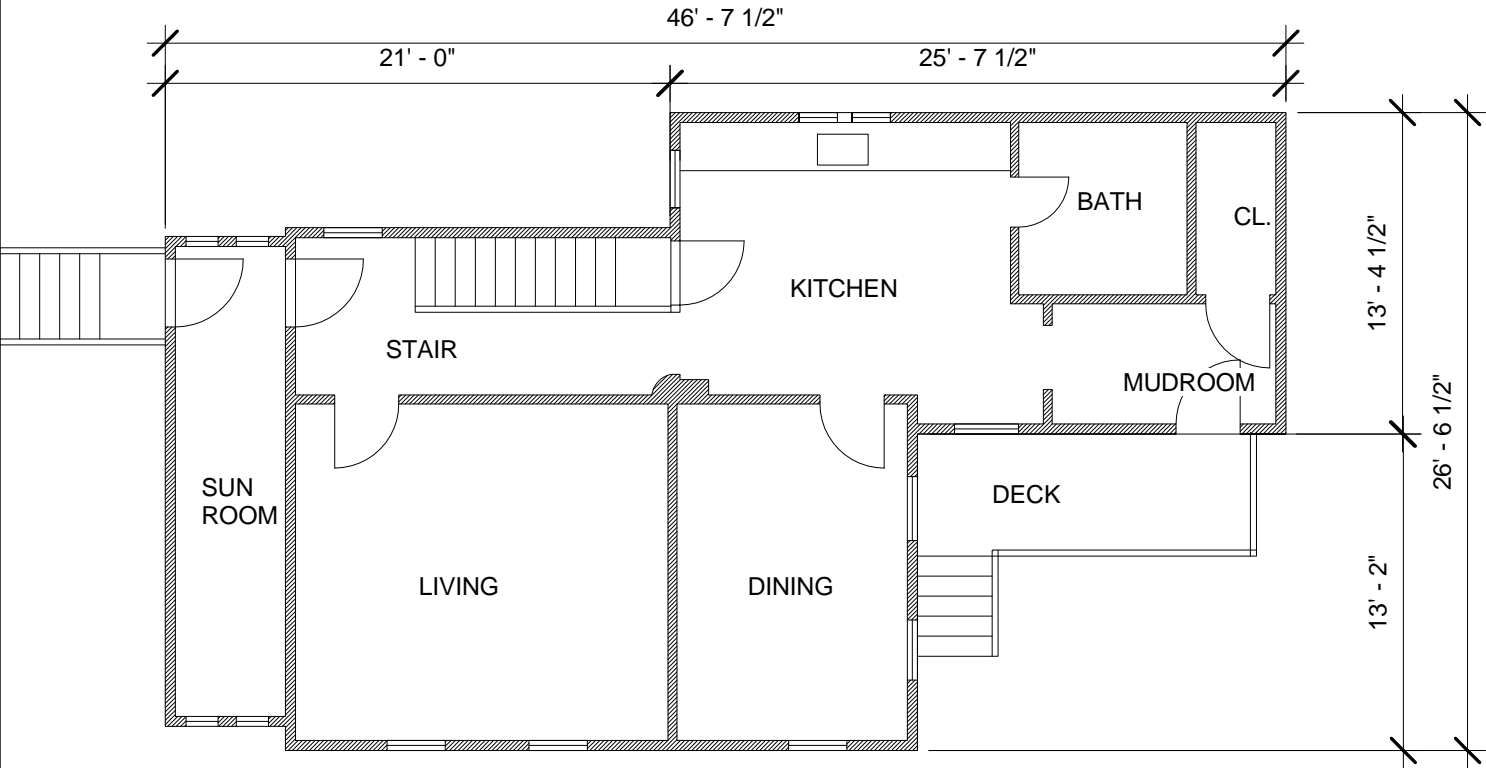

EXISTING 1ST FLOOR PLAN 922 SQUARE FEET

1 EXISTING FLOOR PLANS
1/8" = 1'-0"



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9. Zoning Data						
Refer to the SZO § 2.2 Definitions and SZO § 8 Dimensional Requirements for more information.						
Data	Existing	Proposed	Allowed	Existing or Permitted Nonconformity	New Violation	SZO Section Cited
	Fill in both columns: numbers must match those on plans and other attached documentation.		Office Use			
A. Use	Single Family	2 Family				
B. # of Dwelling Units*	1 units	2 units				
C. Lot Area	4490 square feet	4490 square feet				
D. Lot Area ÷ # of Dwelling Units	4490 sf per du	2245 sf per du				
E. Gross Floor Area of Footprints of All Buildings	1800 square feet	1936 square feet				
F. Ground Coverage (E. ÷ C.)	40 %	43 %				
G. Landscaped Area (landscaped area ÷ C.)	10 %	10 %				
H. Pervious Area (pervious area ÷ C.)	10 %	33 %				
I. Net Floor Area** / *** (sum of all usable square feet)	1369 square feet	2942 square feet				
J. Floor Area Ratio (FAR) (I. ÷ C.)	.3	.65				
K. Building Height	25 feet	35 feet				
L. Front Yard Setback	12 feet	12 feet				
M. Rear Yard Setback	31 feet	30 feet				
N. Side Yard Setback (left when you face property)	0 feet	5 feet				
O. Side Yard Setback (right when you face property)	22'-9.5" feet	19' feet				
P. Street Frontage	50 feet	50 feet				
Q. # of Parking Spaces	4	4				
R. # of Bicycle Parking Spaces	0	4				
S. # of Loading Spaces						
* 8 or more dwelling units - determine if Inclusionary Housing, Article 13, applies						
** In CCD and TOD use GROSS floor area						
*** 30,000+ square feet - determine if Linkage, Article 15, applies						

No.	Description	Date

EXISTING FLOOR PLANS

Project number	Project Number	A0.2
Date	Issue Date	
Drawn by	Author	
Checked by	Checker	
		Scale 1/8" = 1'-0"

NOTES: VERIFY ALL DIMENSIONS IN FIELD PRIOR TO FABRICATION AND CONSTRUCTION. ALL EXISTING CONDITIONS TO REMAIN AS IS UNLESS OTHERWISE NOTED

STRUCTURAL NOTES:

General: Boston basic wind speed (Somerville, MA) 105 mph
Ground snow 40 psf
All loads and loading conditions are per IBC 2015 (9th edition of the Massachusetts Building Code)

ALL WORK SHALL CONFORM TO THE LATEST COMMONWEALTH OF MASSACHUSETTS STATE BUILDING CODE AND THE INTERNATIONAL BUILDING CODE.
ALL FOUNDATIONS SHALL REST ON SOLID BEARING (MIN. CAPACITY 2T/SF). WHERE RESTING ON FILL, SUCH FILL'S MATERIAL & COMPACTION METHOD SHALL BE AS APPROVED IN WRITING BY THE ENGINEER. NOTIFY THE ENGINEER IF LESSER CAPACITY MATERIAL IS ENCOUNTERED BEFORE PROCEEDING WITH THE WORK.

ALL WOOD SHALL BE PRESSURE TREATED SELECT STRUCTURAL FOR DECKS/PORCHES AND WHERE INDICATED IN DRAWINGS.

ALL LOADS AND LOADING CONDITIONS ARE PER IBC 2015 (9TH EDITION OF THE MASSACHUSETTS BUILDING CODE)
LVL BEAMS : FB=3100 PSL
CONCRETE : FC=3000 psi
REINFORCEMENT: FY=60 KSI
ALL DIMENSIONAL LUMBER SHALL BE OF CONSTRUCTION GRADE OR BETTER;
ALL EXPOSED WOOD SHALL BE PRESSURE TREATED;
ALL EXPOSED CONNECTORS AND FASTENERS SHALL BE GALVANIZED;
ALL STRUCTURAL COLUMNS ARE 6X4 PSL OR 3.5 "LALLYS, UNO

PROVIDE BRACING OF ALL COLUMNS(STEEL AND TIMBER) AT EACH FLOOR LEVEL. USE SIMPSON HURRICANE TIES TO ATTACH ROOF RAFTERS TO THE WALLS.

NAILING AND FASTENING:

ALL FASTENERS AND CONNECTORS SHOULD BE GALVANIZED. USE 4" O.C. @ EDGES AND 12" O.C. IN FIELD TO ATTACH ALL FLOOR AND ROOF PLYWOOD AND EXTERIOR SHEATHING.

CONTRACTOR MAY SUBSTITUTE SINGLE LVL BEAMS FOR COMBINATION OF 1.75"PILES.


ALL COMBINED LVL PILES SHALL BE CONNECTED PER MANUFACTURER SPECIFICATION FOR SIDE-LOADED ASSEMBLIES.

THE CONTRACTOR SHALL VERIFY ALL EXISTING CONDITIONS AND DIMENSIONS IN THE FIELD AND SHALL NOTIFY THE ENGINEER OF ANY DISCREPANCY BEFORE PROCEEDING WITH THE WORK.


THE CONTRACTOR SHALL PROVIDE ALL NECESSARY SHORING & BRACING UNTIL ALL STRUCTURAL WORK IS COMPLETE.

BUILDING ENVELOPE REQUIREMENTS SHOULD BE IN COMPLIANCE WITH MASSACHUSETTS BUILDING CODE 9TH EDITION 780 CMR 13.00 (IECC 2015 CHAPTER 5.00)


ARCHITECTURAL SYMBOLS LEGEND

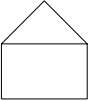


"EXTERIOR" ELEVATIONS

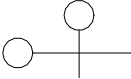


COLUMN REFERENCE LINE

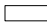


ROOM NUMBER




DOOR NUMBER

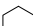


WINDOW TYPE




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
REVISION REFERENCE




WALL WIDTH
PARTITION TYPE

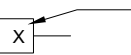


DOOR HEAD/JAMB/SILL DETAIL REF.

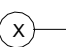


PROPOSED ELEVATION
IN ELEVATION OR SECTION



CENTER LINE



HIDDEN EDGES/PROJECTIONS ABOVE

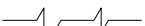


BREAK LINE


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SYMBOLS


NOT TO SCALE




"INTERIOR" SECTIONS

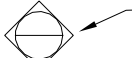


DETAIL (MAY NOT APPLY)
"INTERIOR" ELEVATIONS




WALL SECTION




SECTION OR DETAIL




REFERENCE DETAIL

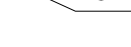


DRAWING WHERE DETAIL IS DRAWN

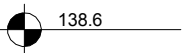


138.6 SPOT ELEVATION




ACOUSTICAL TILE CEILING GRID

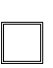


RECESSED FLUORESCENT LIGHT FIXTURE

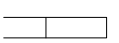


SURFACE OR PENDANT MOUNTED
FLUORESCENT LIGHT FIXTURE
SUPPLY OR RETURN AIR DIFFUSER OR GRILLE

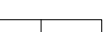


SURFACE OR PENDANT MOUNTED
FLUORESCENT LIGHT FIXTURE




RECESSED INCANDESCENT LIGHT FIXTURE




SURFACE OR PENDANT MOUNTED
INCANDESCENT LIGHT FIXTURE




WALL MOUNTED INCANDESCENT
LIGHT FIXTURE




LIGHTING TRACK




RECESSED INCANDESCENT WALL
WASHER




EXIT LIGHT




PAGING SPEAKER




SMOKE OR HEAT DETECTOR



SPRINKLER HEAD

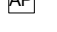

ACCESS PANEL



FE
FEC

FIRE EXTINGUISHER
FIRE EXTINGUISHER & CABINET

GENERAL NOTES:

- A. IT WILL BE THE CONTRACTORS RESPONSIBILITY TO VERIFY AND EXECUTE ALL WORK IN STRICT ACCORDANCE WITH ALL MASSACHUSETTS STATE BUILDING CODE AND, INTERNATIONAL BUILDING CODE AND OTHER REGULATIONS.
- B. DO NOT SCALE THE DRAWINGS. VERIFY ALL CONDITIONS AND DIMENSIONS ON THE JOB SITE BEFORE STARTING WORK AND TO COORDINATE WITH WORK ACCORDINGLY. THE CONTRACTOR SHALL REPORT ALL DISCREPANCIES TO THE ENGINEER AND THE DESIGNER PROMPTLY AND PRIOR TO ANY CONSTRUCTION. CONTRACTOR SHALL PROVIDE IN WRITING TO OWNER, ARCHITECT AND ENGINEER REQUEST FOR ADDITIONAL INFORMATION OF SCOPE OF WORK. IN THE ABSENCE OF THIS WRITTEN REQUEST, SCOPE OF WORK SHALL BE DETERMINED AS UNDERSTOOD BY CONTRACTOR.
- C. THE GENERAL CONTRACTOR IS RESPONSIBLE FOR ALL WORK SHOWN IN THE CONTRACT DOCUMENTS EXCEPT WHERE SPECIFICALLY DESIGNATED TO BE DONE BY A SEPARATE SUBCONTRACTOR OR BY A CONTRACTOR WORKING DIRECTLY FOR THE OWNER. THE GENERAL CONTRACTOR IS RESPONSIBLE FOR COORDINATING THE WORK OF THESE CONTRACTORS.
- D. THE GENERAL CONTRACTOR IS TO DO ALL CUTTING AND PATCHING OF EXISTING FLOOR, WALL, CEILING, ROOFS FOR ANY NEW PLUMBING HVAC, OR ELECTRICAL WORK, EVEN IF THE CUTTING AND PATCHING IS NOT SPECIFICALLY IDENTIFIED.
- E. THE GENERAL CONTRACTOR SHALL BE RESPONSIBLE FOR INITIATING, MAINTAINING AND SUPERVISING ALL SAFETY PRECAUTIONS AND PROGRAMS NECESSARY FOR THE COMPLETION OF THE WORK.
- F. ALL WORK TO BE CONSIDERED NEW WORK UNLESS INDICATED OTHERWISE. CONTRACTOR SHALL VERIFY WITH OWNER AND ENGINEER SCOPE OF NEW WORK VERSUS EXISTING CONDITION TO REMAIN PRIOR TO COMMENCE OF WORK. THIS VERIFICATION SHALL BE PROVIDED IN A WRITTEN FORMAT ALONG WITH MARK-UPS ON PLANS
- G. THE GENERAL CONTRACTOR SHALL FILE FOR AND SECURE ALL APPROVALS. PERMITS AND CERTIFICATES OF COMPLIANCE AS REQUIRED AND PAY FOR SUCH FEES.
- H. THE GENERAL CONTRACTOR IS RESPONSIBLE FOR A COMPLETE AND THOROUGH CLEAN UP AT THE END OF THE PROJECT, AND FOR DAILY CLEAN-UP OF CONSTRUCTION DEBRIS.
- I. THE GENERAL CONTRACTOR IS TO ENSURE WHERE EXISTING CONSTRUCTION IS TO REMAIN, FIRE RESISTIVE CONSTRUCTION IS TO BE COMPLETE AND UNINTERRUPTED. GENERAL CONTRACTOR IS TO REPAIR AND PARCH EXITING CONSTRUCTION WITH FIRE RESISTIVE CONSTRUCTION OF SAME OR HIGHER RATING.



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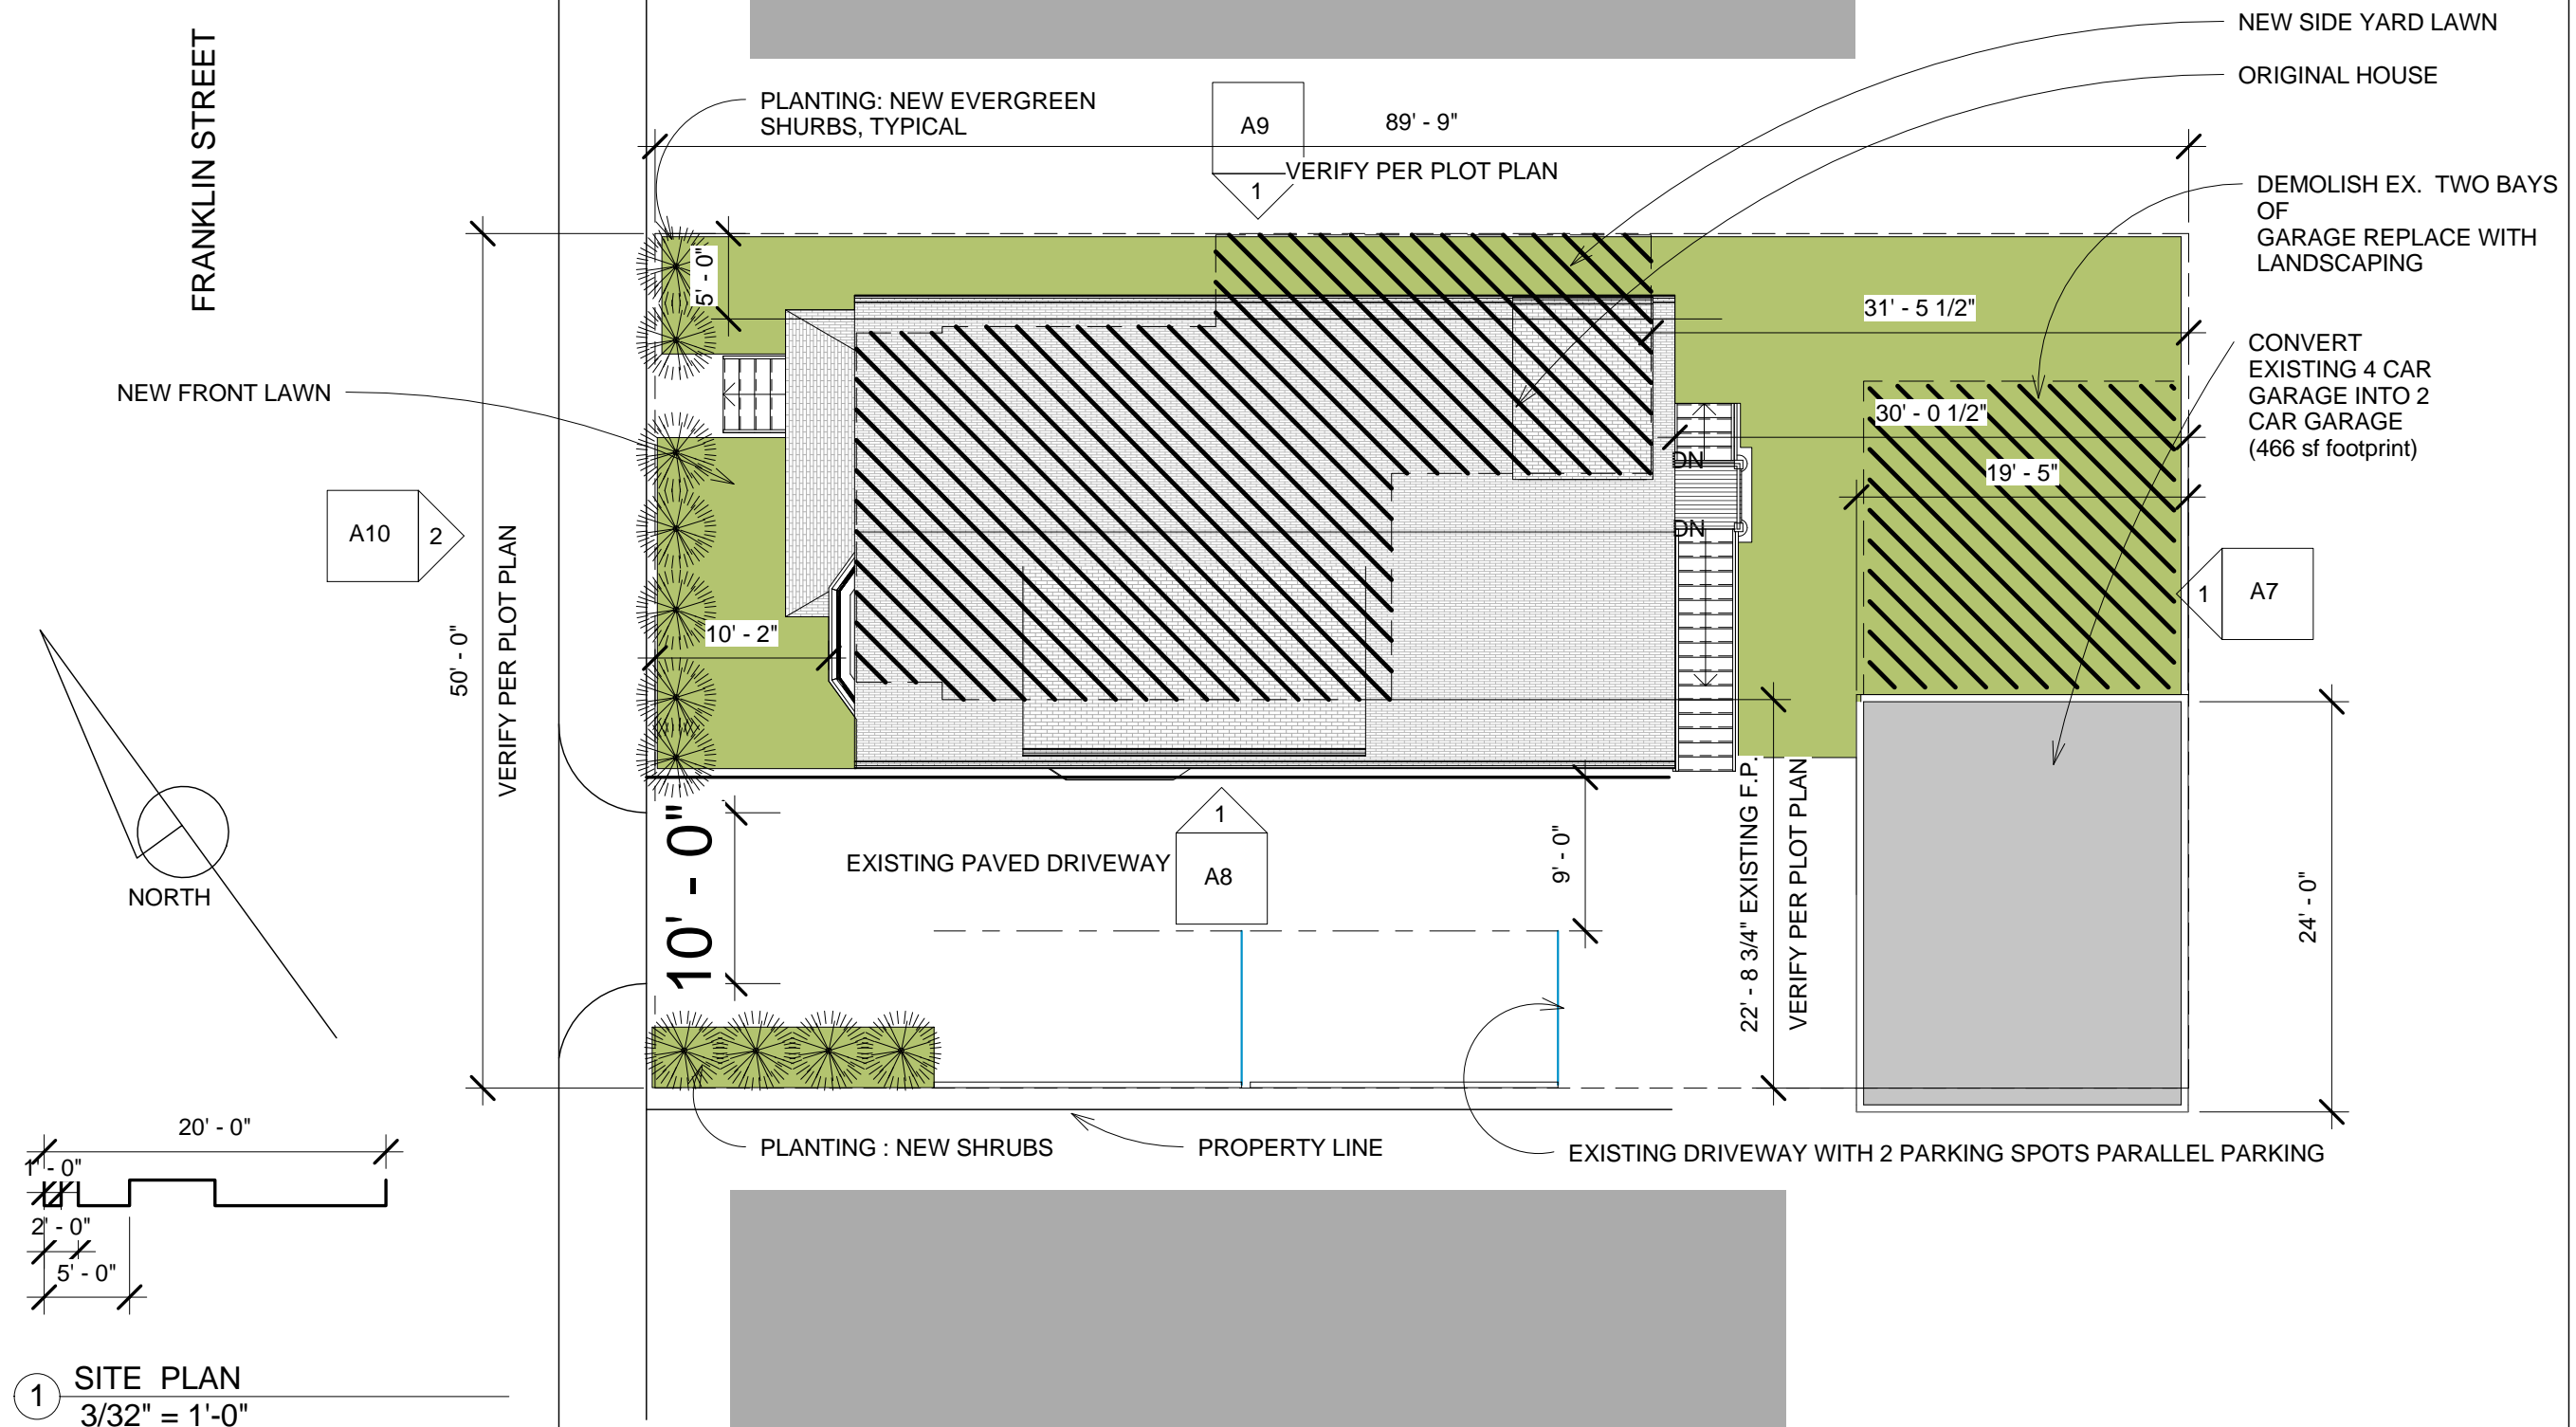
30 FRANKLIN STREET,
SOMERVILLE, MA
TRIPLE DECKER REVIVAL

No.	Description	Date

NOTES AND SYMBOLS

Project number	Project Number	A0.3
Date	Issue Date	
Drawn by	Author	
Checked by	Checker	
Scale		6" = 1'-0"

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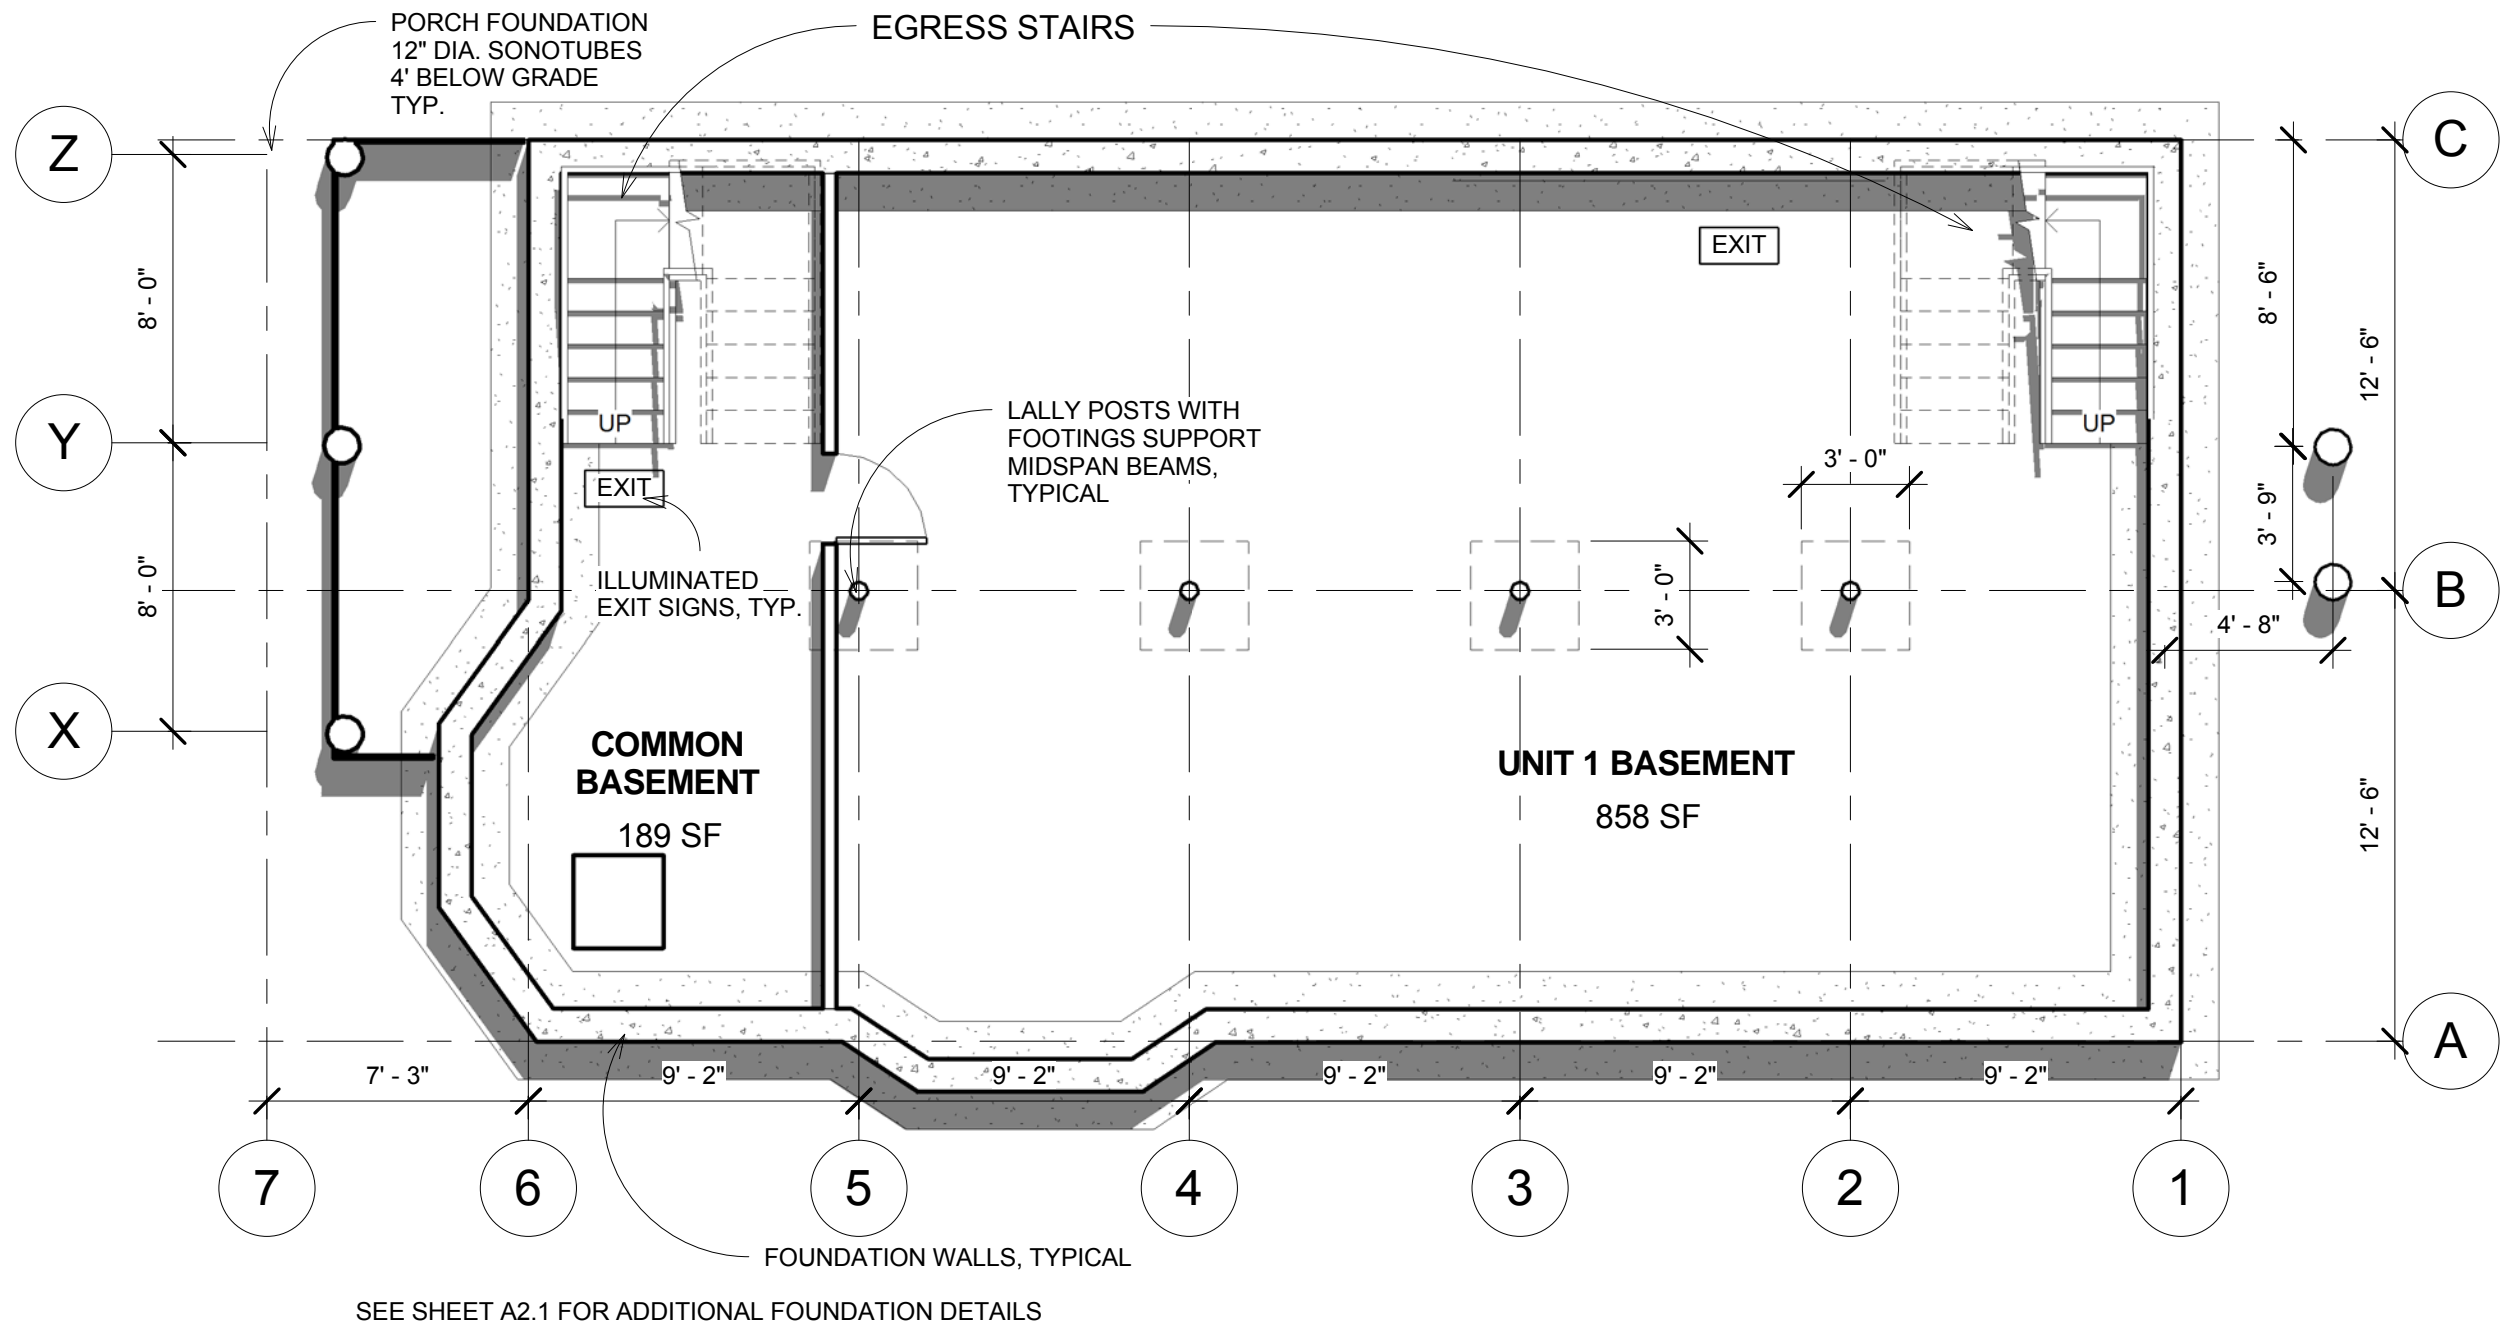
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[illegible]

SITE PLAN

Project number	Project Number	<div style="text-align: center; font-size: 48pt; font-weight: bold;">A1</div>
Date	Issue Date	
Drawn by	Author	
Checked by	Checker	
		Scale 3/32" = 1'-0"

NOTES: VERIFY ALL DIMENSIONS IN FIELD PRIOR TO FABRICATION AND CONSTRUCTION. ALL EXISTING CONDITIONS TO REMAIN AS IS UNLESS OTHERWISE NOTED



1 BASEMENT LEVEL
3/16" = 1'-0"



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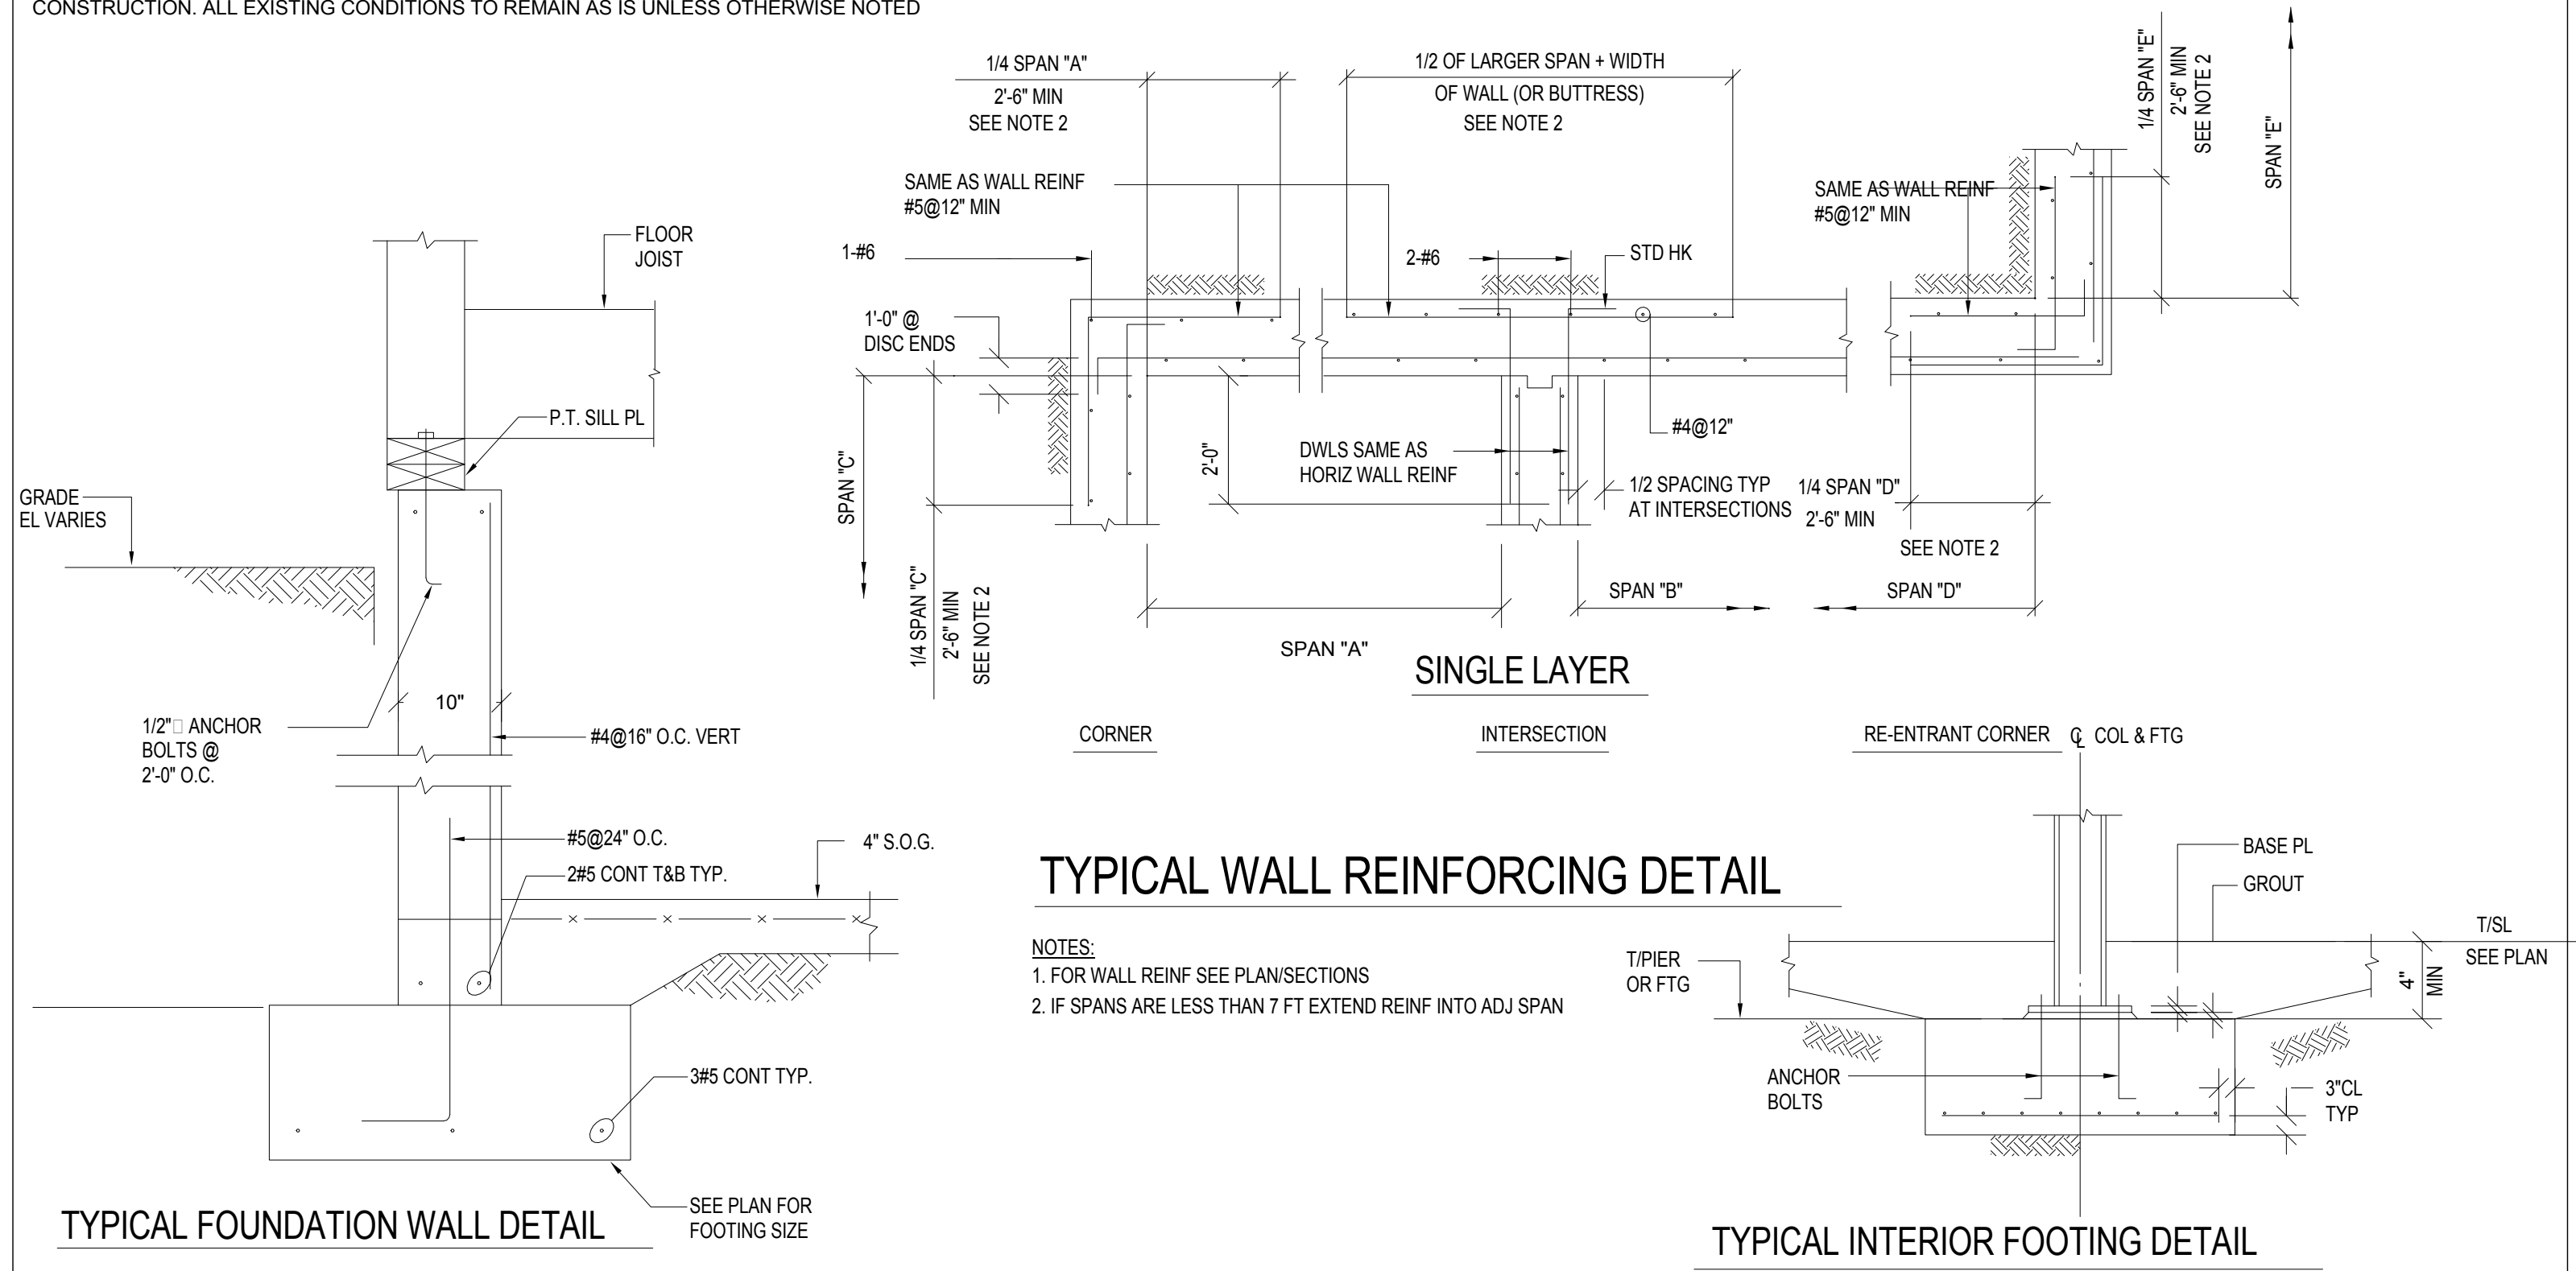
No.	Description	Date

BASEMENT LEVEL

Project number	Project Number
Date	Issue Date
Drawn by	Author
Checked by	Checker

A2
Scale 3/16" = 1'-0"

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TYPICAL FOUNDATION WALL DETAIL

TYPICAL WALL REINFORCING DETAIL

- NOTES:
- 1. FOR WALL REINF SEE PLAN/SECTIONS
 - 2. IF SPANS ARE LESS THAN 7 FT EXTEND REINF INTO ADJ SPAN

TYPICAL INTERIOR FOOTING DETAIL

1 FOUNDATION DETAILS
1" = 1'-0"




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No.	Description	Date

FOUNDATION DETAILS		
Project number	Project Number	A2.1
Date	Issue Date	
Drawn by	Author	
Checked by	Checker	
		Scale 1" = 1'-0"

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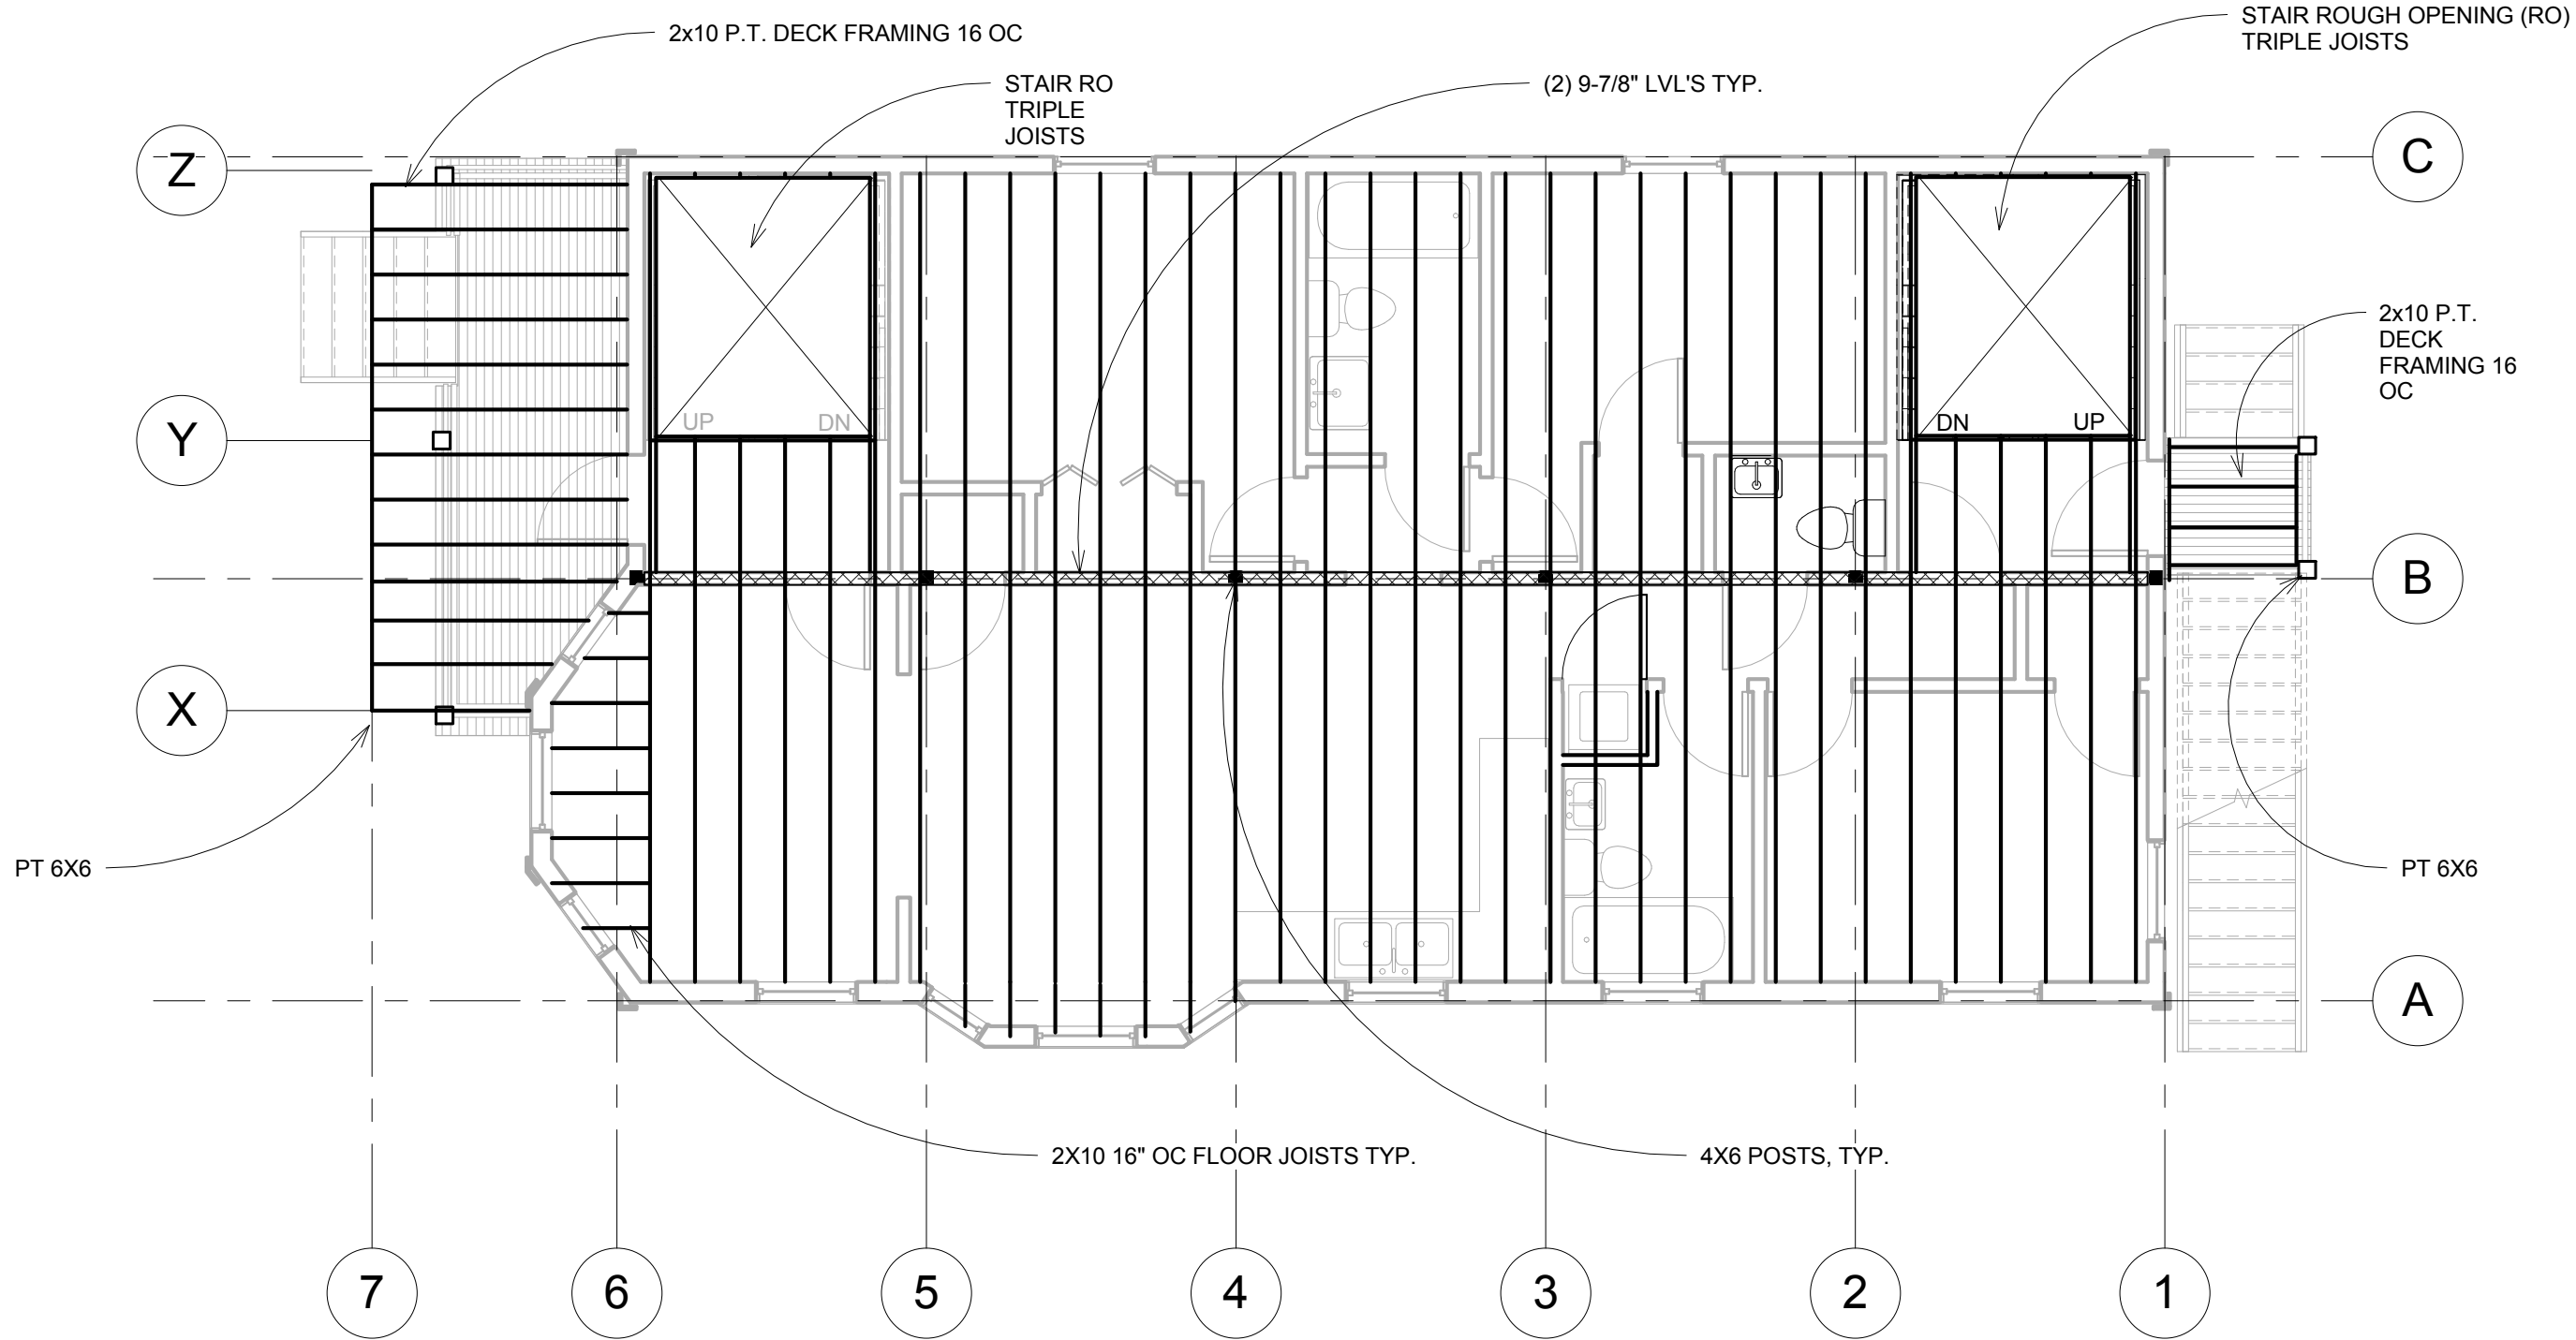
No.	Description	Date

FIRST FLOOR - UNIT 1

Project number	Project Number
Date	Issue Date
Drawn by	Author
Checked by	Checker

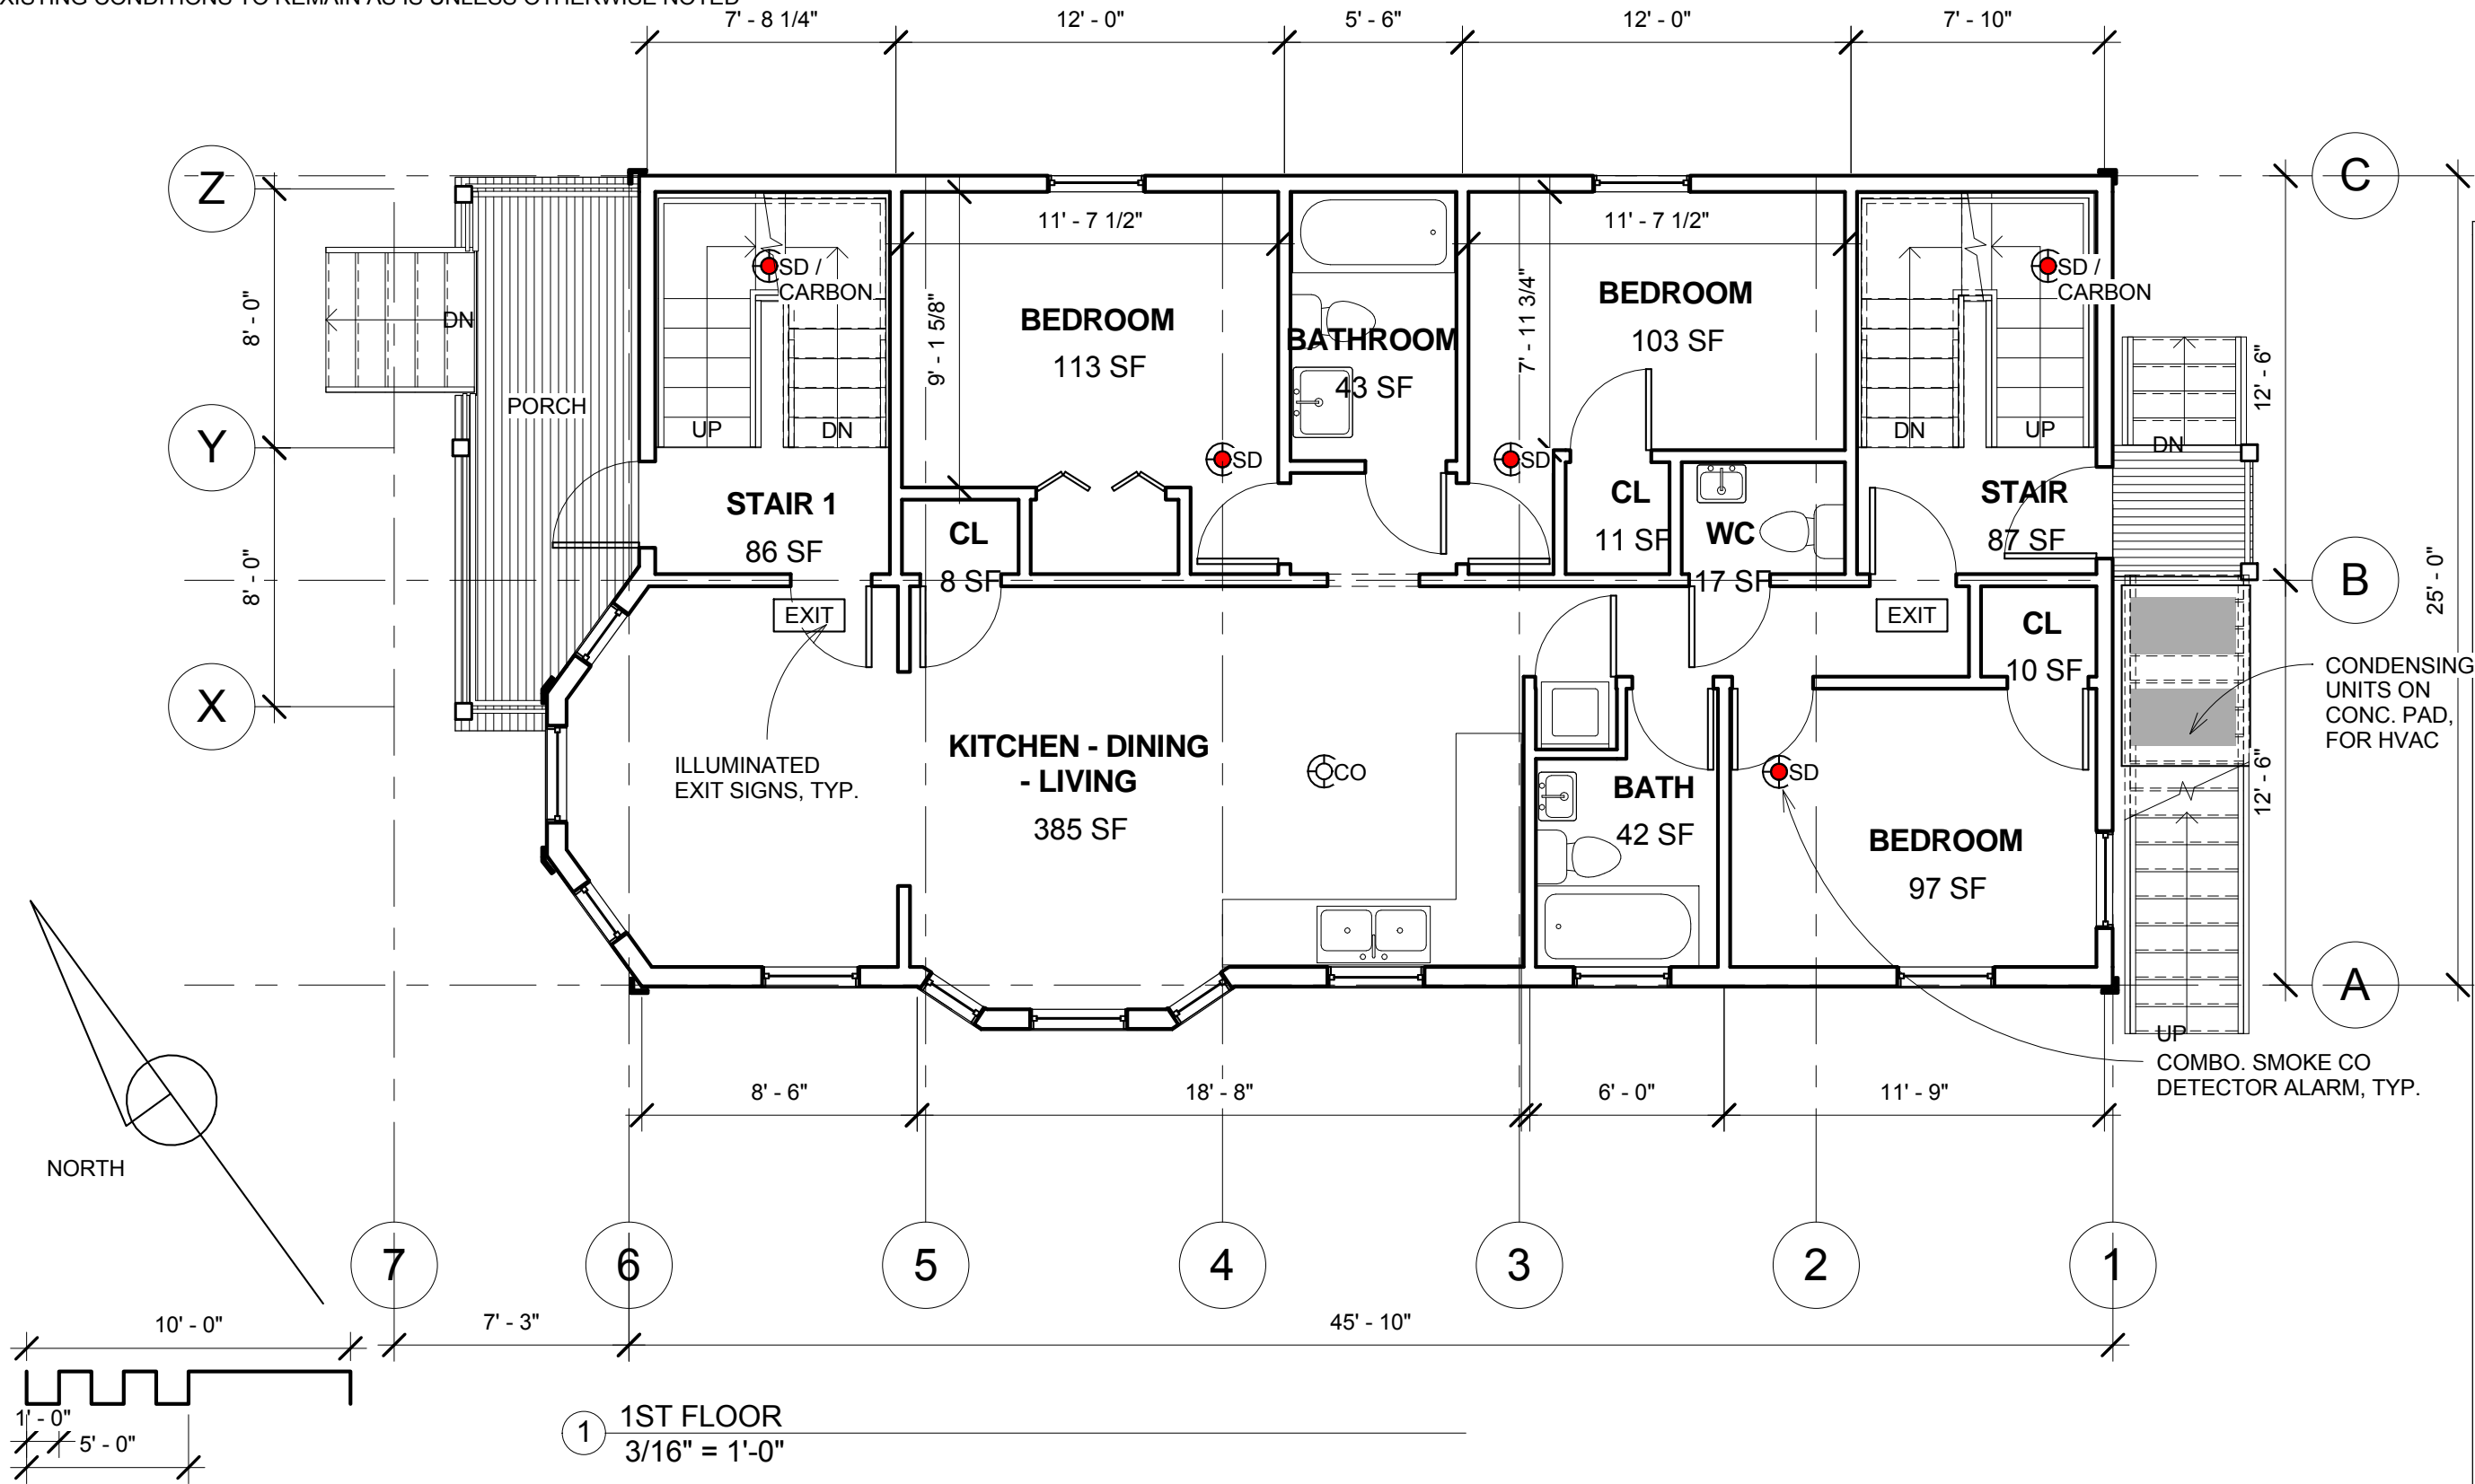A3
Scale 3/16" = 1'-0"

NOTES: VERIFY ALL DIMENSIONS IN FIELD PRIOR TO FABRICATION AND CONSTRUCTION. ALL EXISTING CONDITIONS TO REMAIN AS IS UNLESS OTHERWISE NOTED



1 1ST FLOOR FRAMING
3/16" = 1'-0"



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SOMERVILLE, MA
TRIPLE DECKER REVIVAL


No.	Description	Date

1ST FLOOR FRAMING

Project number	Project Number
Date	Issue Date
Drawn by	Author
Checked by	Checker

A3.1
Scale 3/16" = 1'-0"

NOTES: VERIFY ALL DIMENSIONS IN FIELD PRIOR TO FABRICATION AND CONSTRUCTION. ALL EXISTING CONDITIONS TO REMAIN AS IS UNLESS OTHERWISE NOTED

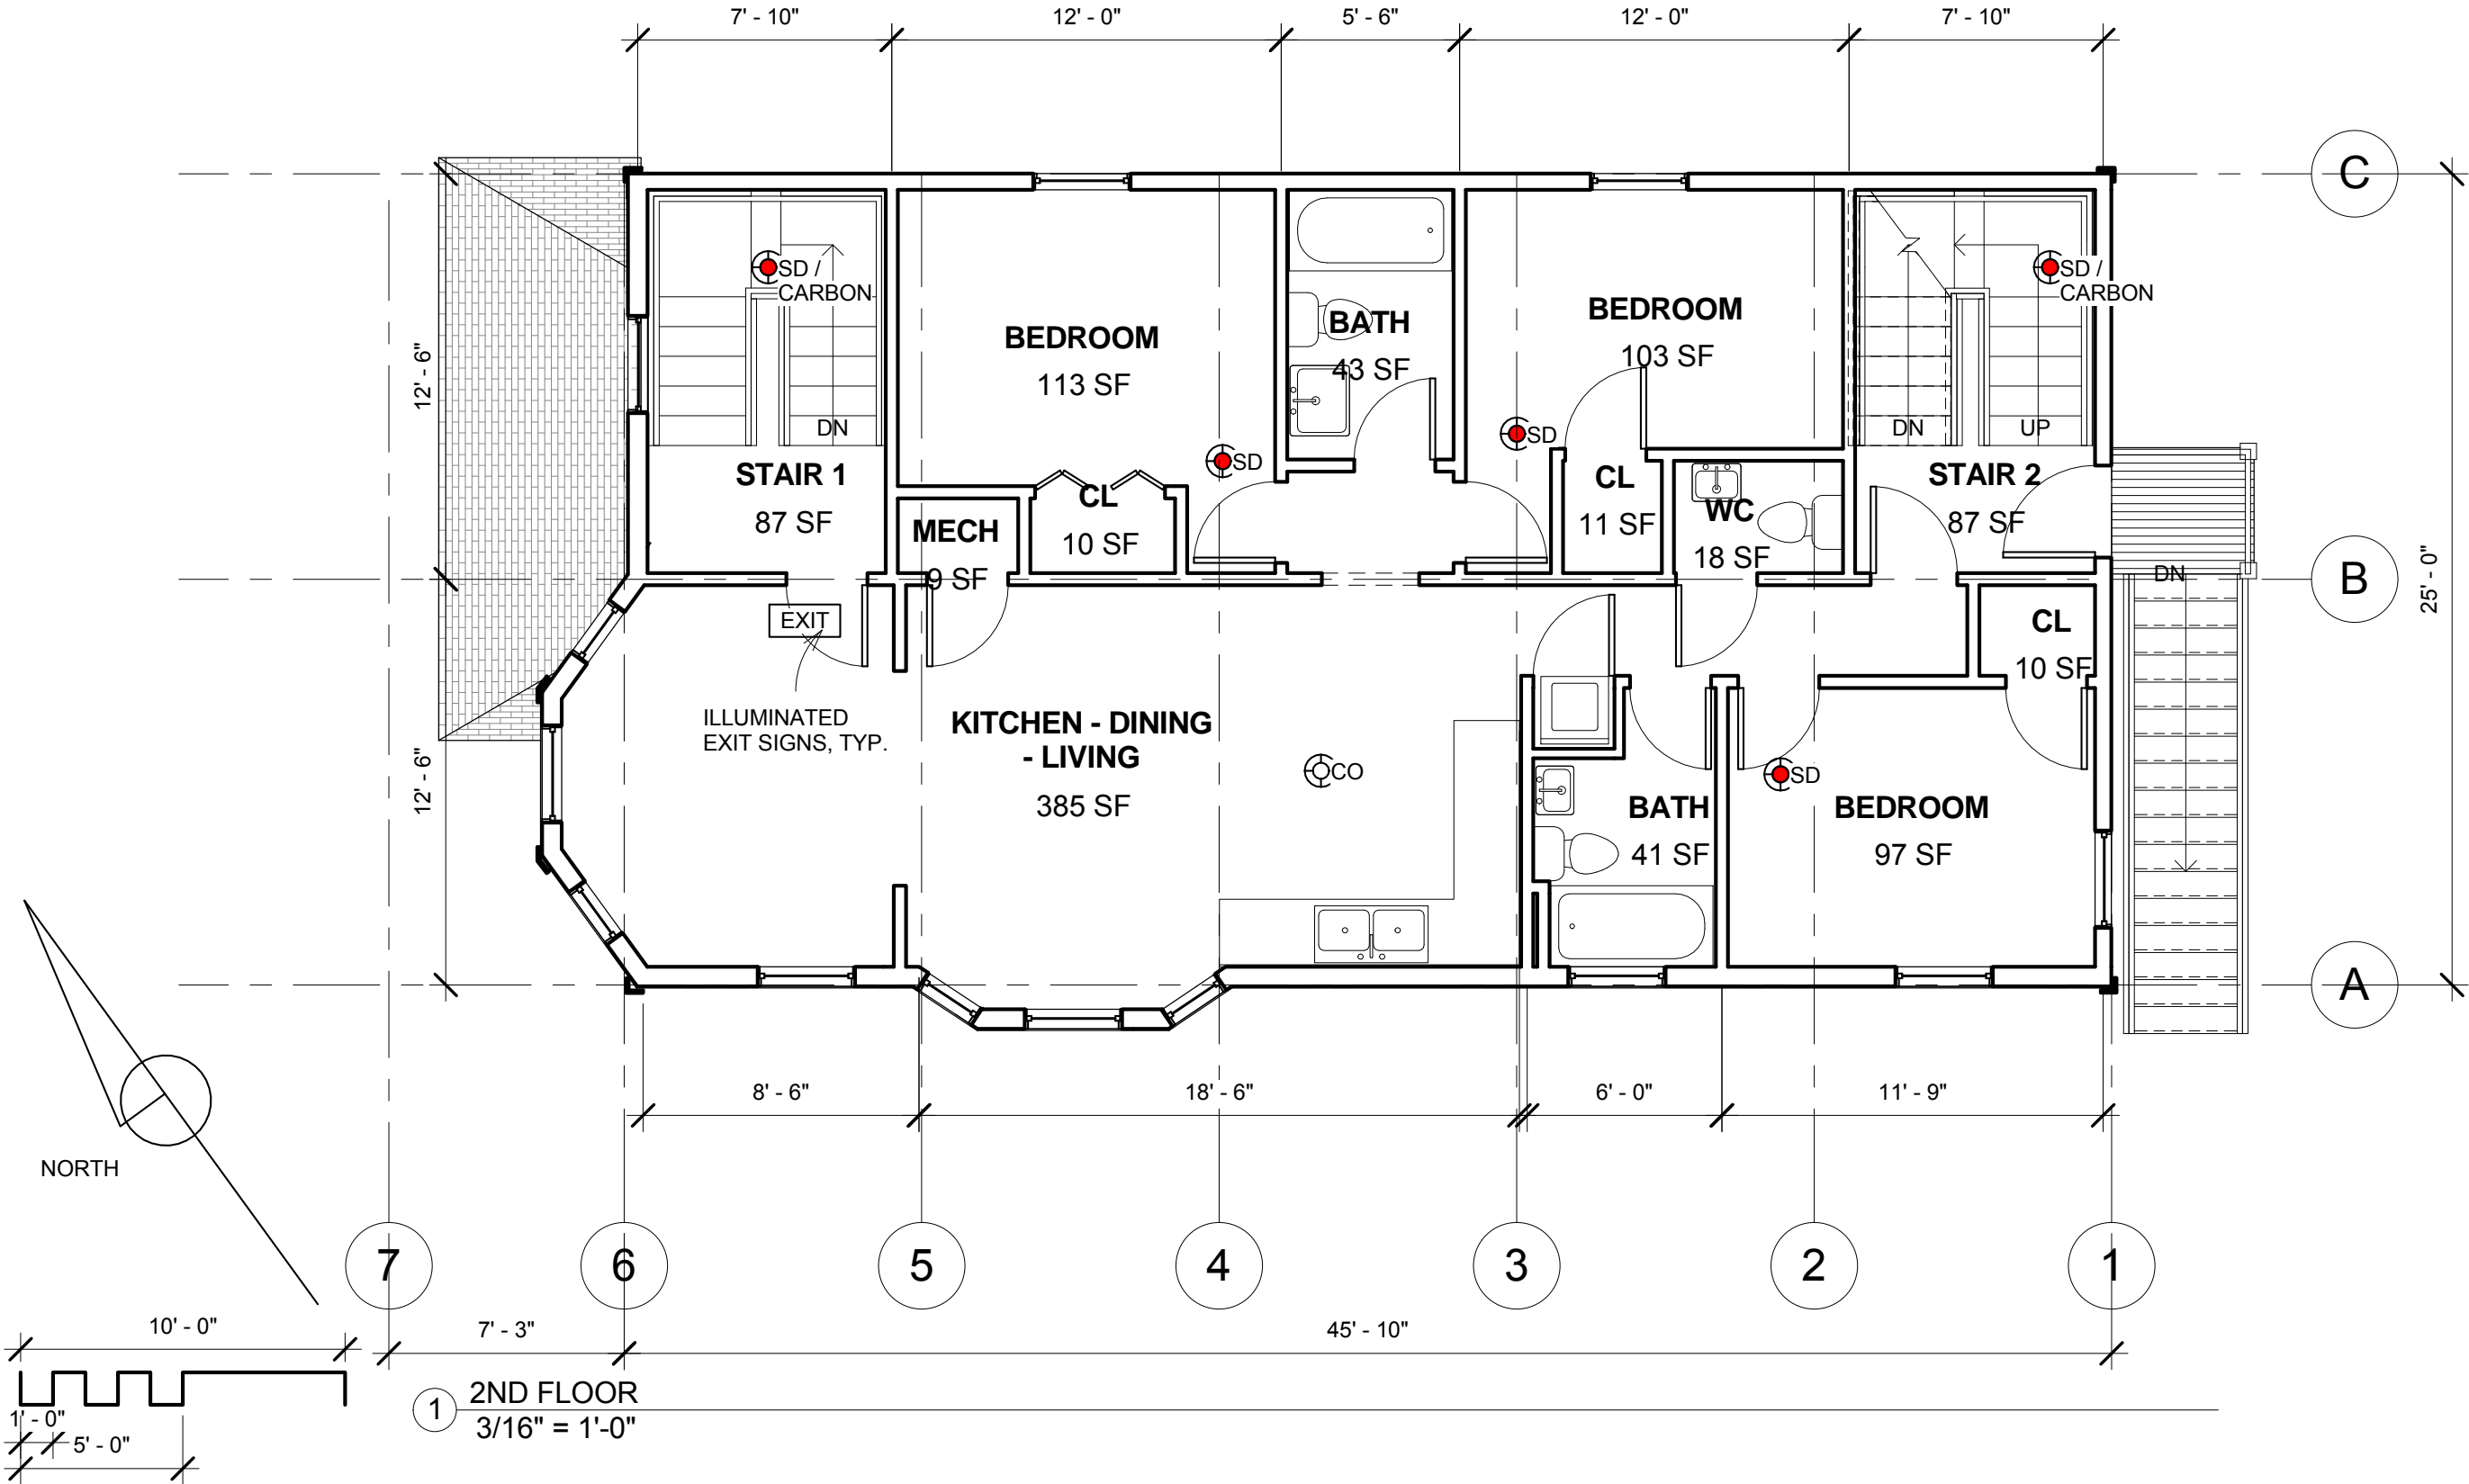

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No.	Description	Date


SECOND FLOOR - UNIT 2

Project number	Project Number
Date	Issue Date
Drawn by	Author
Checked by	Checker

A4

Scale 3/16" = 1'-0"

NOTES: VERIFY ALL DIMENSIONS IN FIELD PRIOR TO FABRICATION AND CONSTRUCTION. ALL EXISTING CONDITIONS TO REMAIN AS IS UNLESS OTHERWISE NOTED

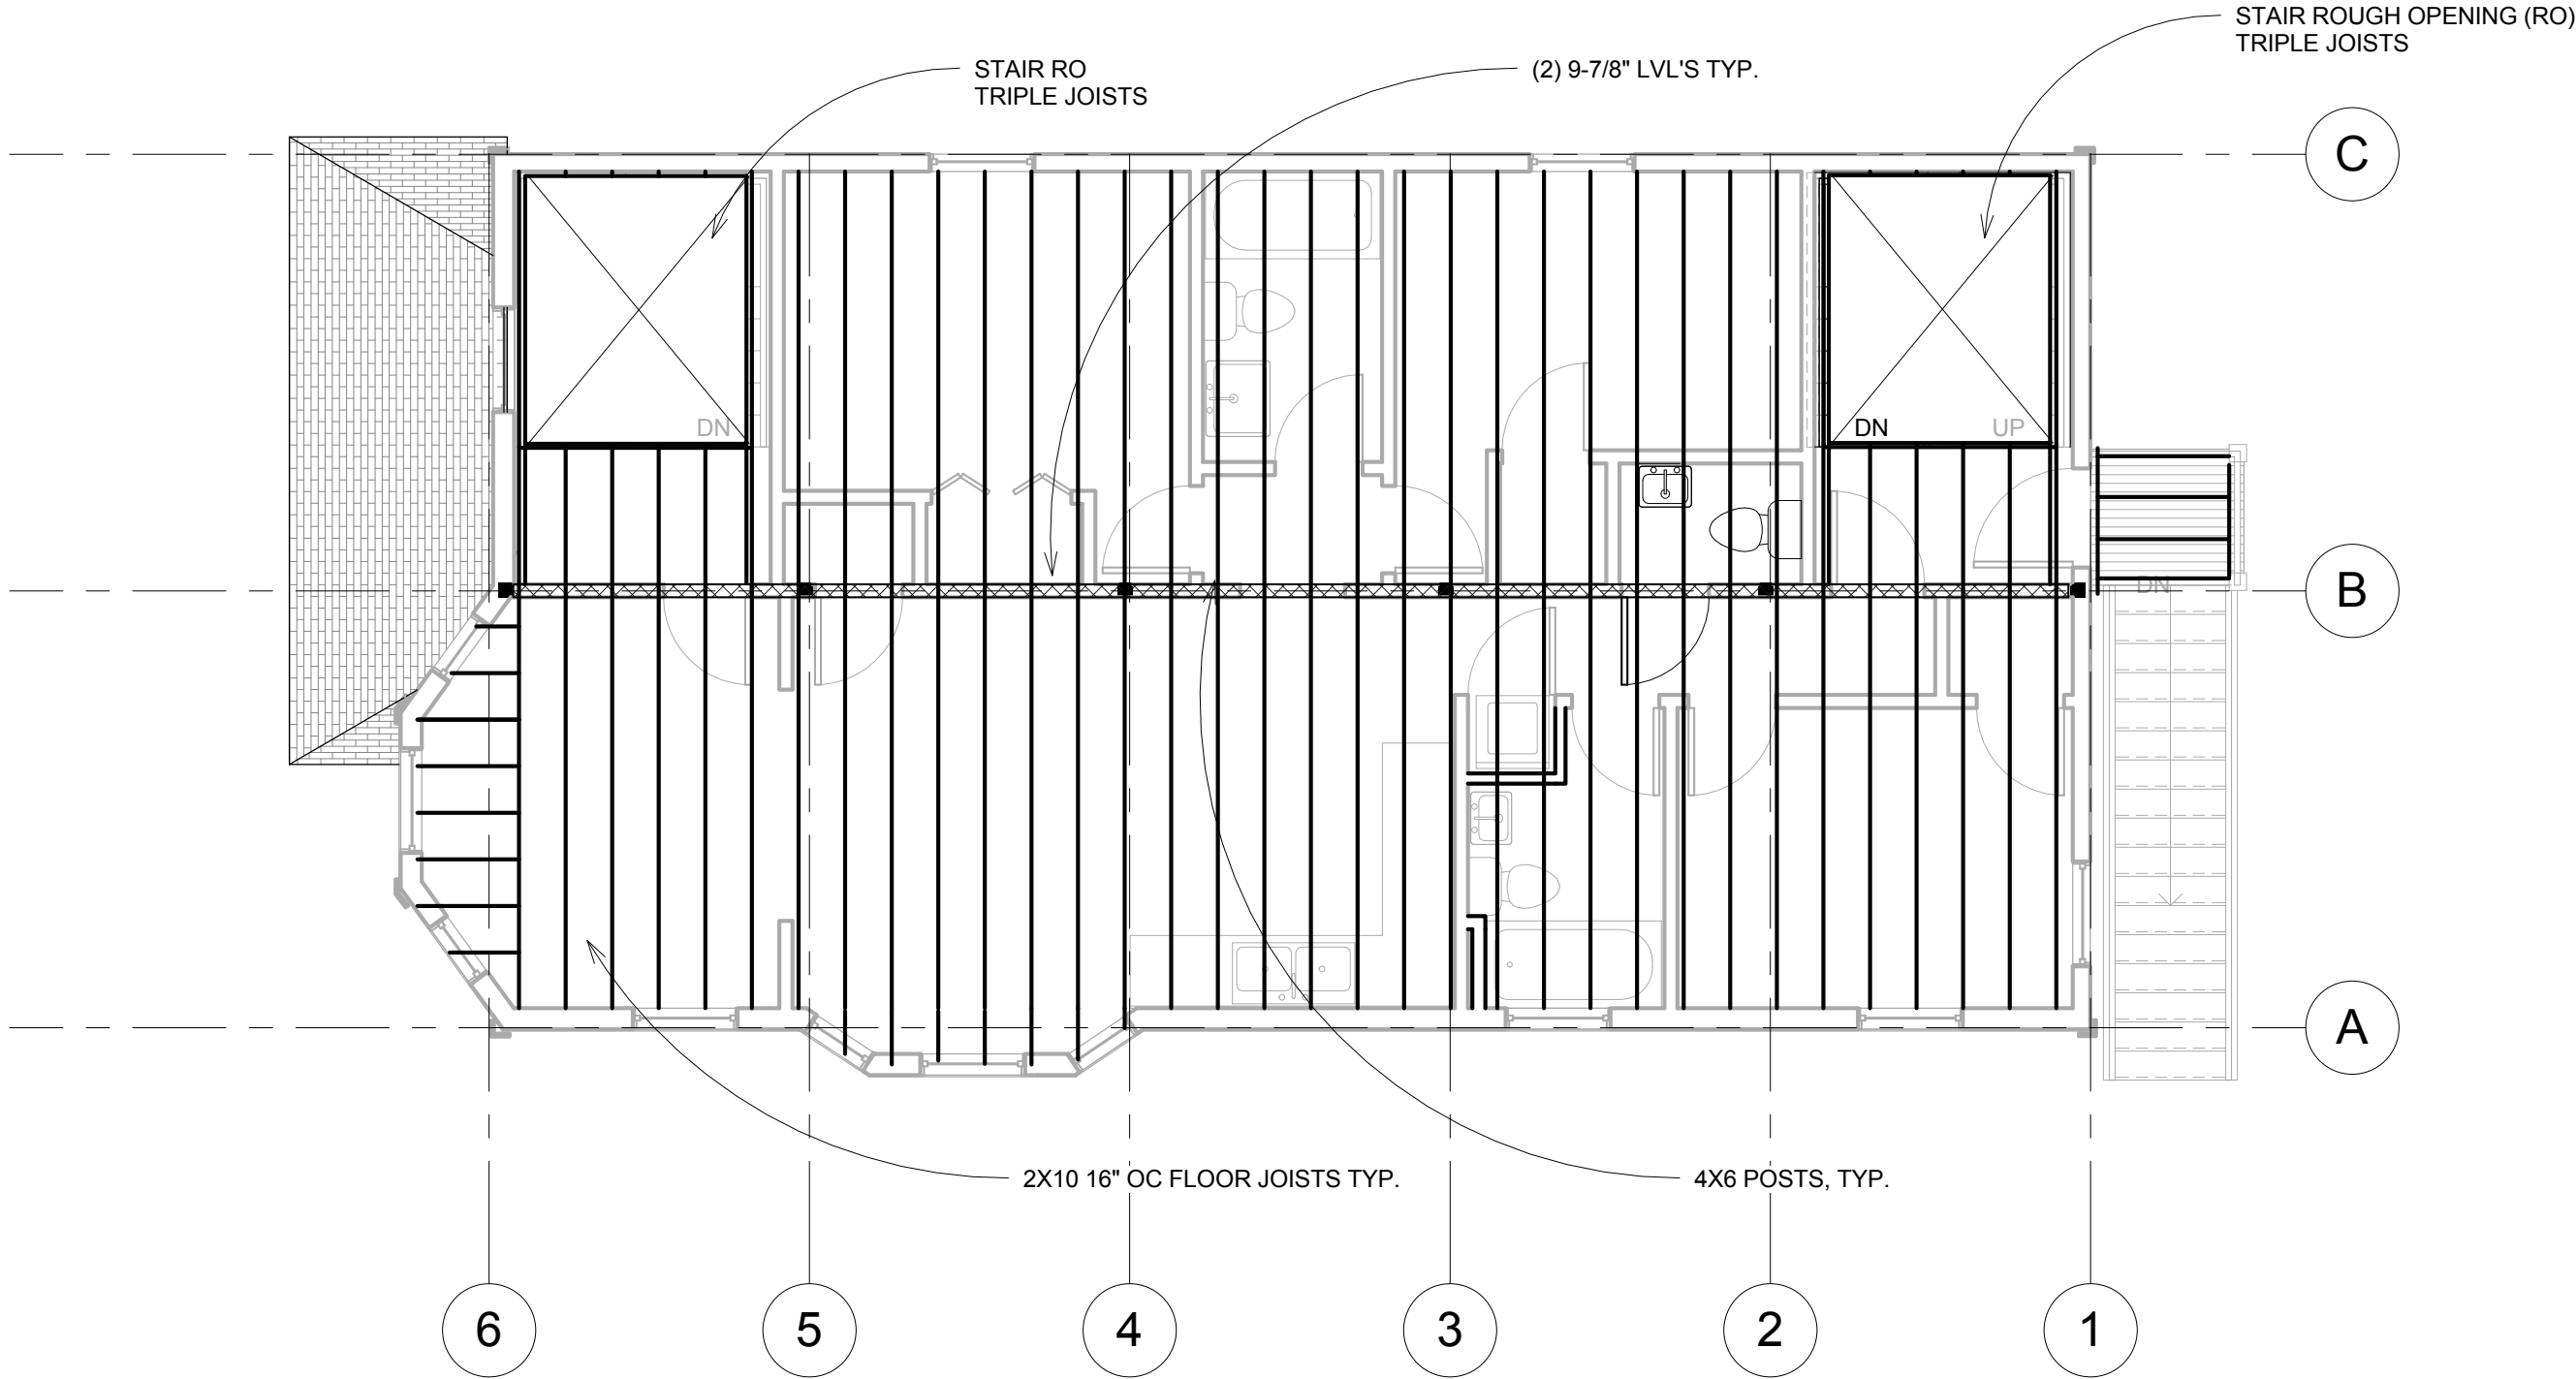

1 2ND FLOOR FRAMING
3/16" = 1'-0"



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No.	Description	Date


2ND FLOOR FRAMING

Project number	Project Number
Date	Issue Date
Drawn by	Author
Checked by	Checker

A4.1

Scale 3/16" = 1'-0"

NOTES: VERIFY ALL DIMENSIONS IN FIELD PRIOR TO FABRICATION AND CONSTRUCTION. ALL EXISTING CONDITIONS TO REMAIN AS IS UNLESS OTHERWISE NOTED

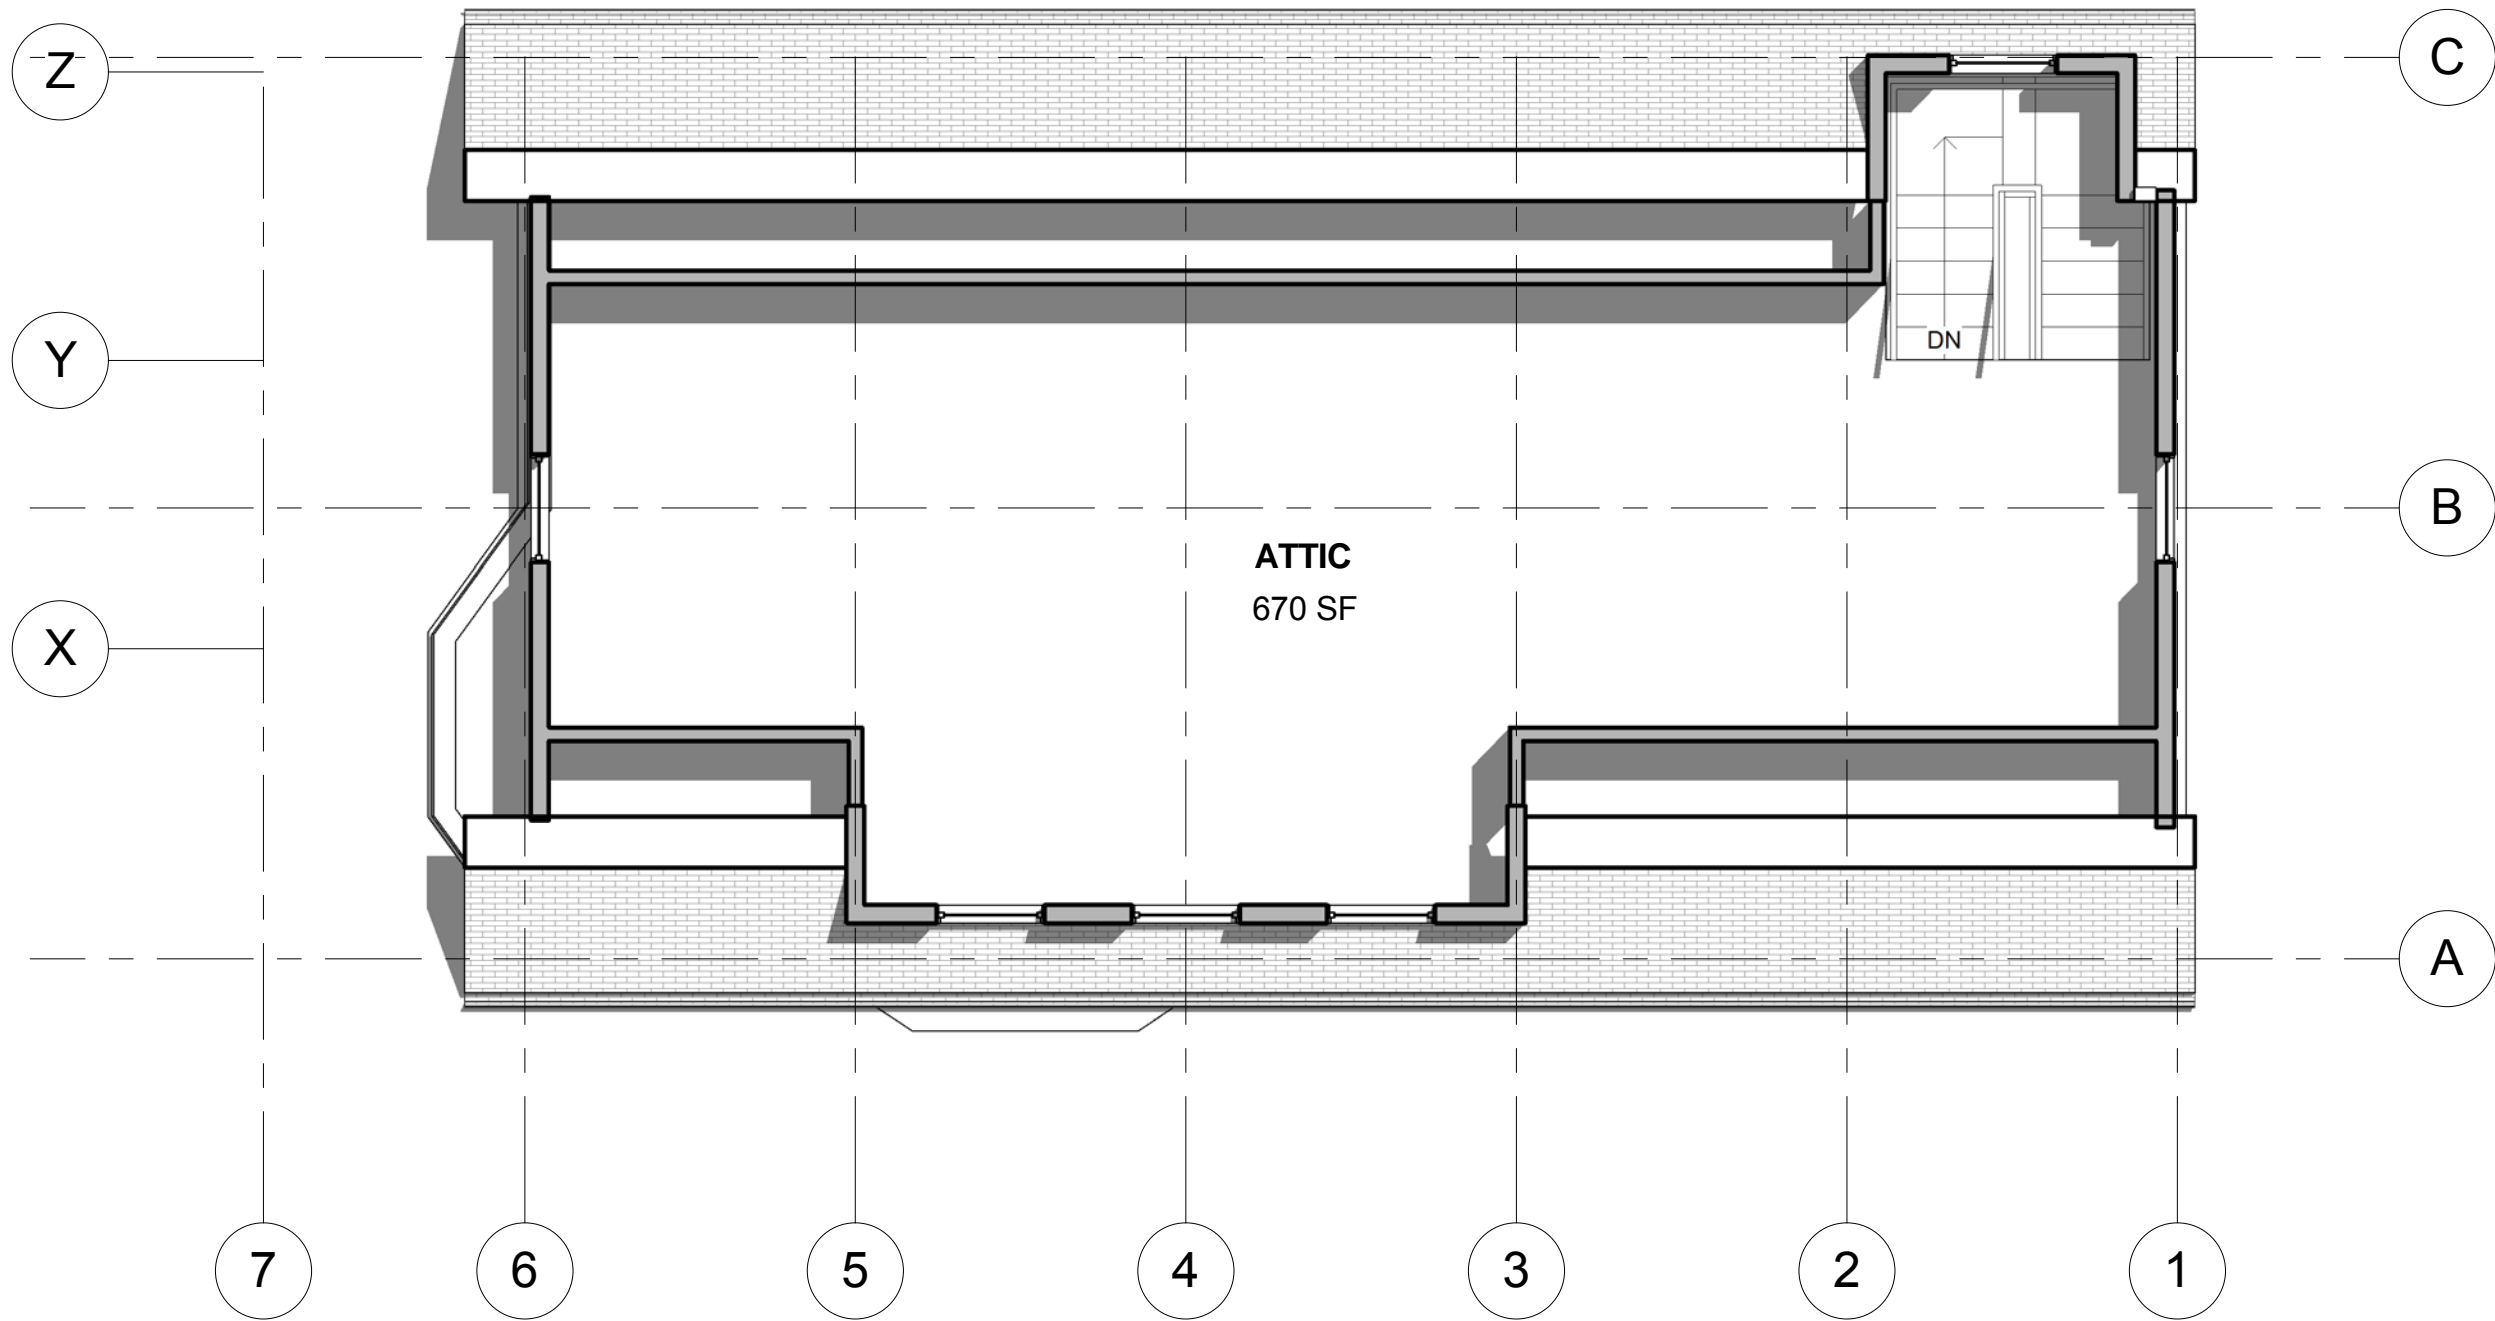

1 ATTIC LEVEL
3/16" = 1'-0"



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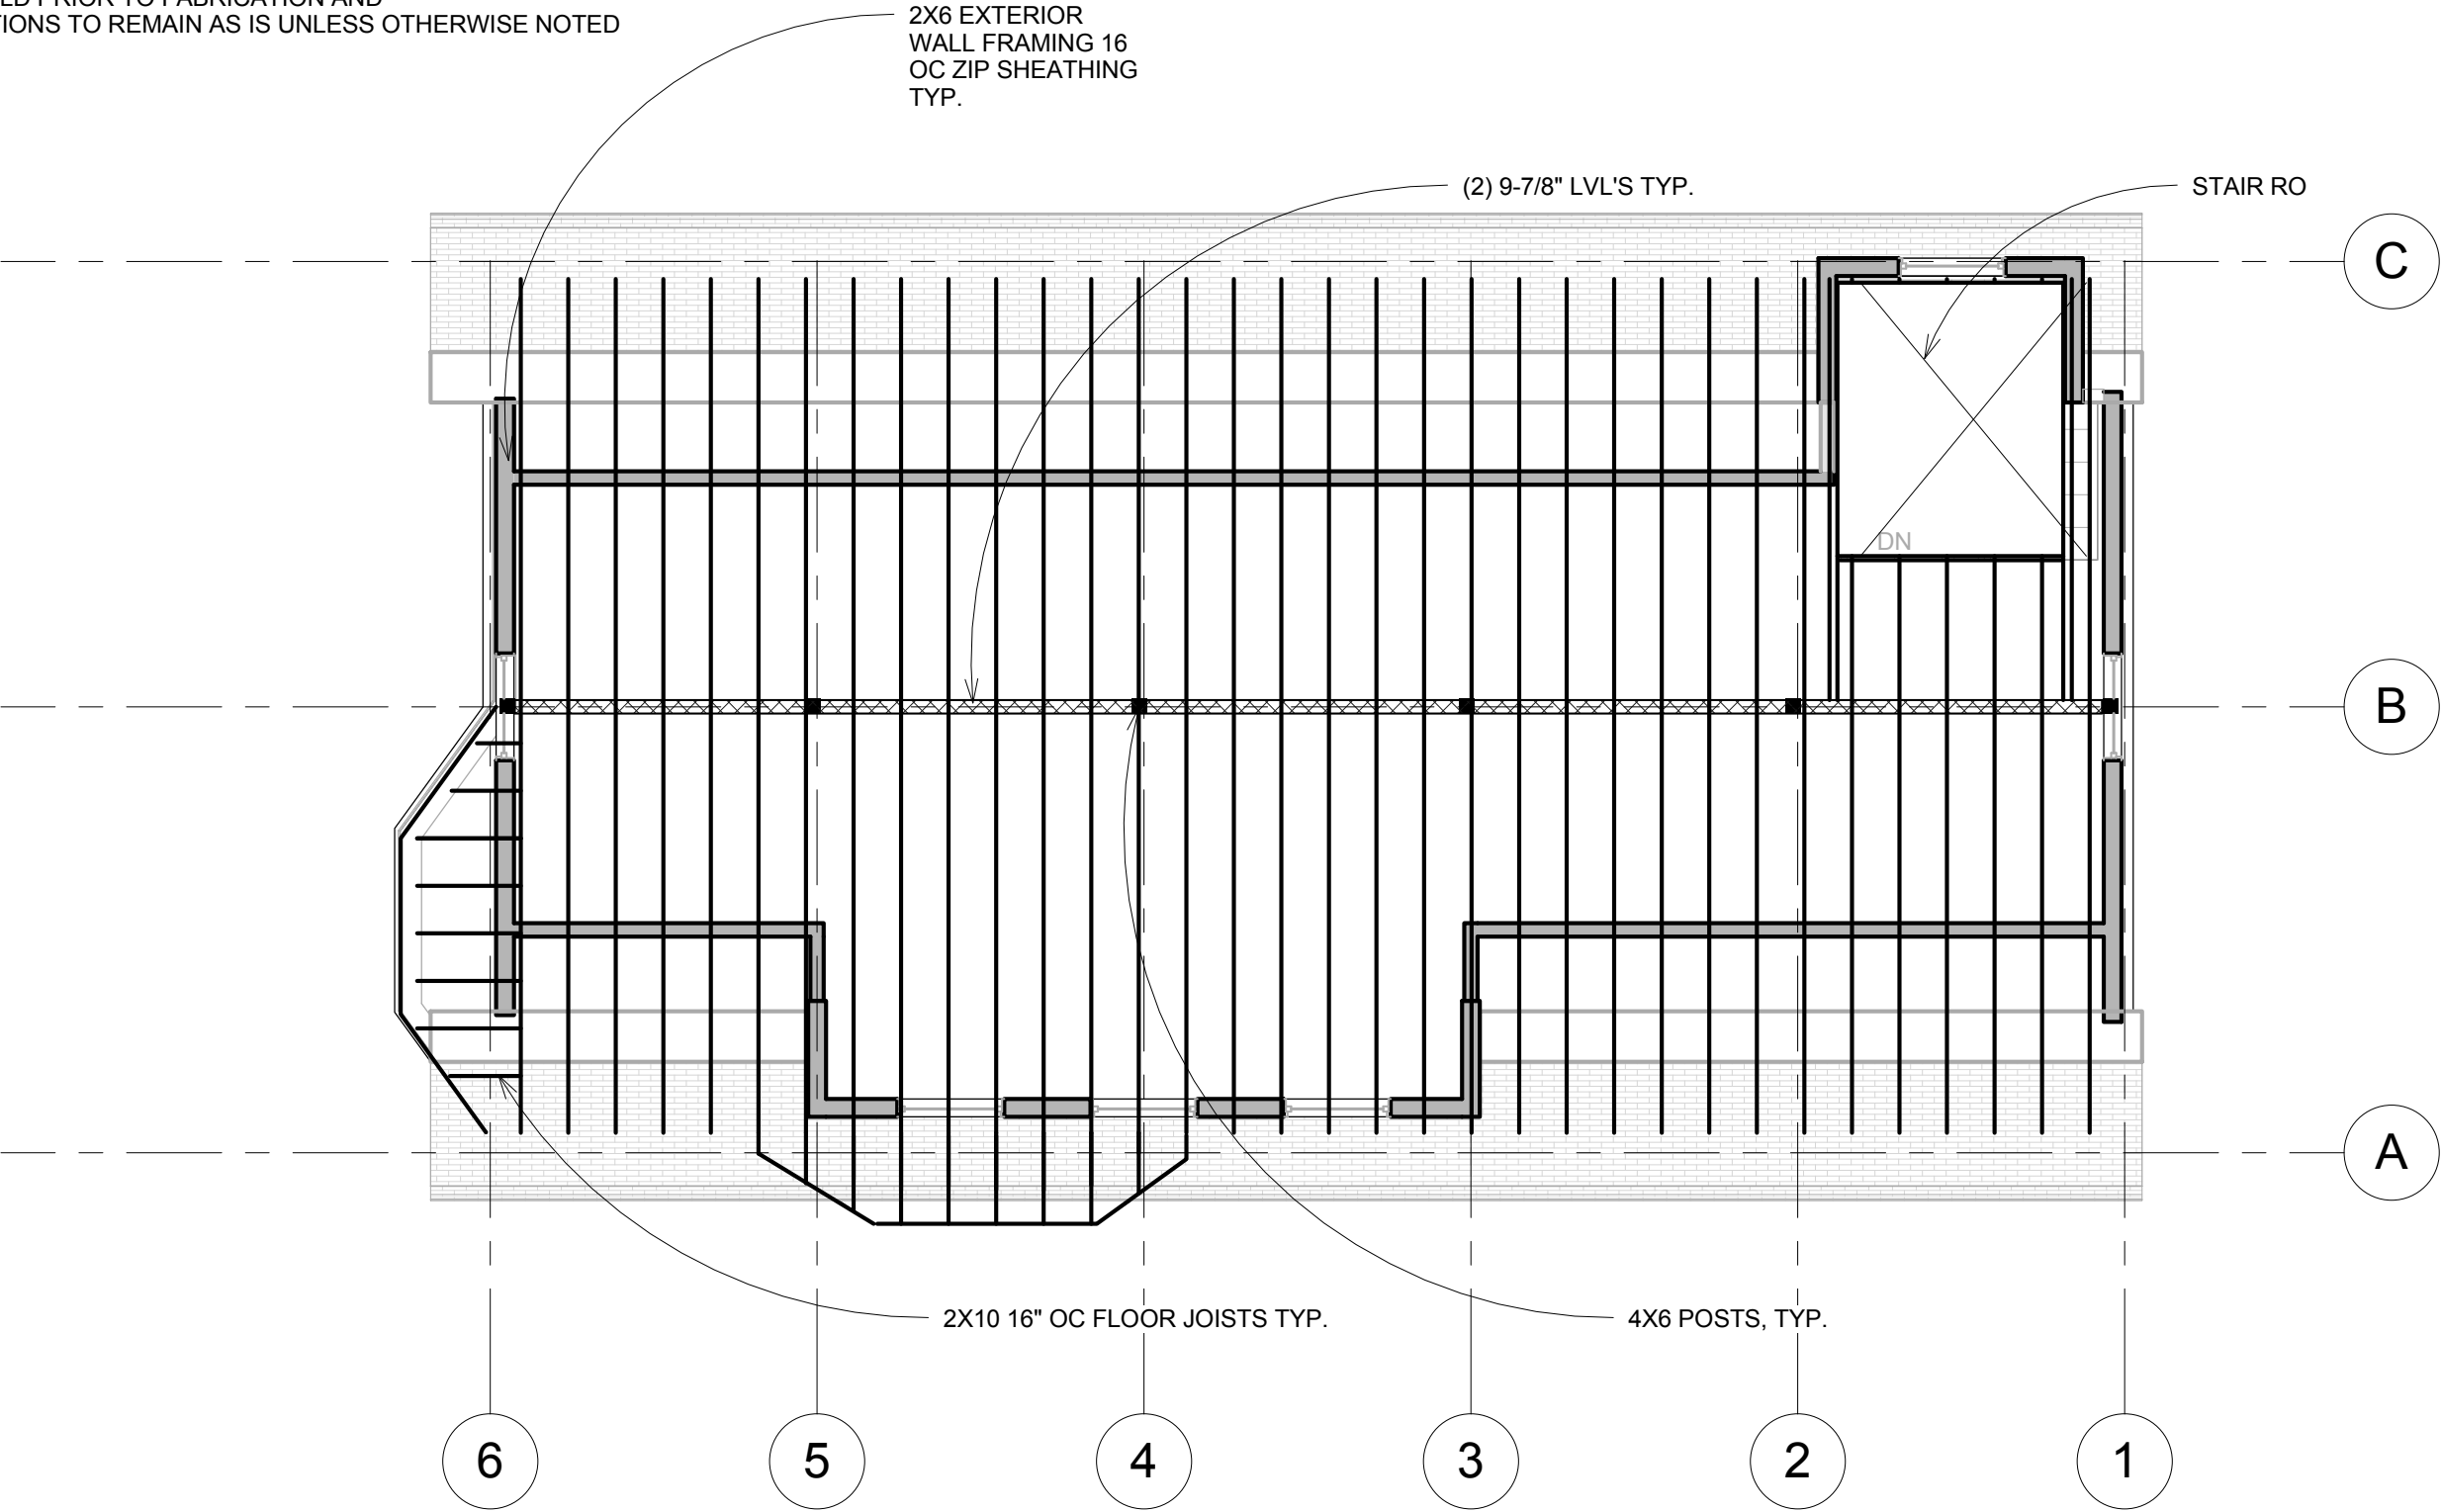
No.	Description	Date

ATTIC LEVEL - UNIT 2

Project number	Project Number
Date	Issue Date
Drawn by	Author
Checked by	Checker

A5
Scale 3/16" = 1'-0"

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1 ATTIC FRAMING
3/16" = 1'-0"



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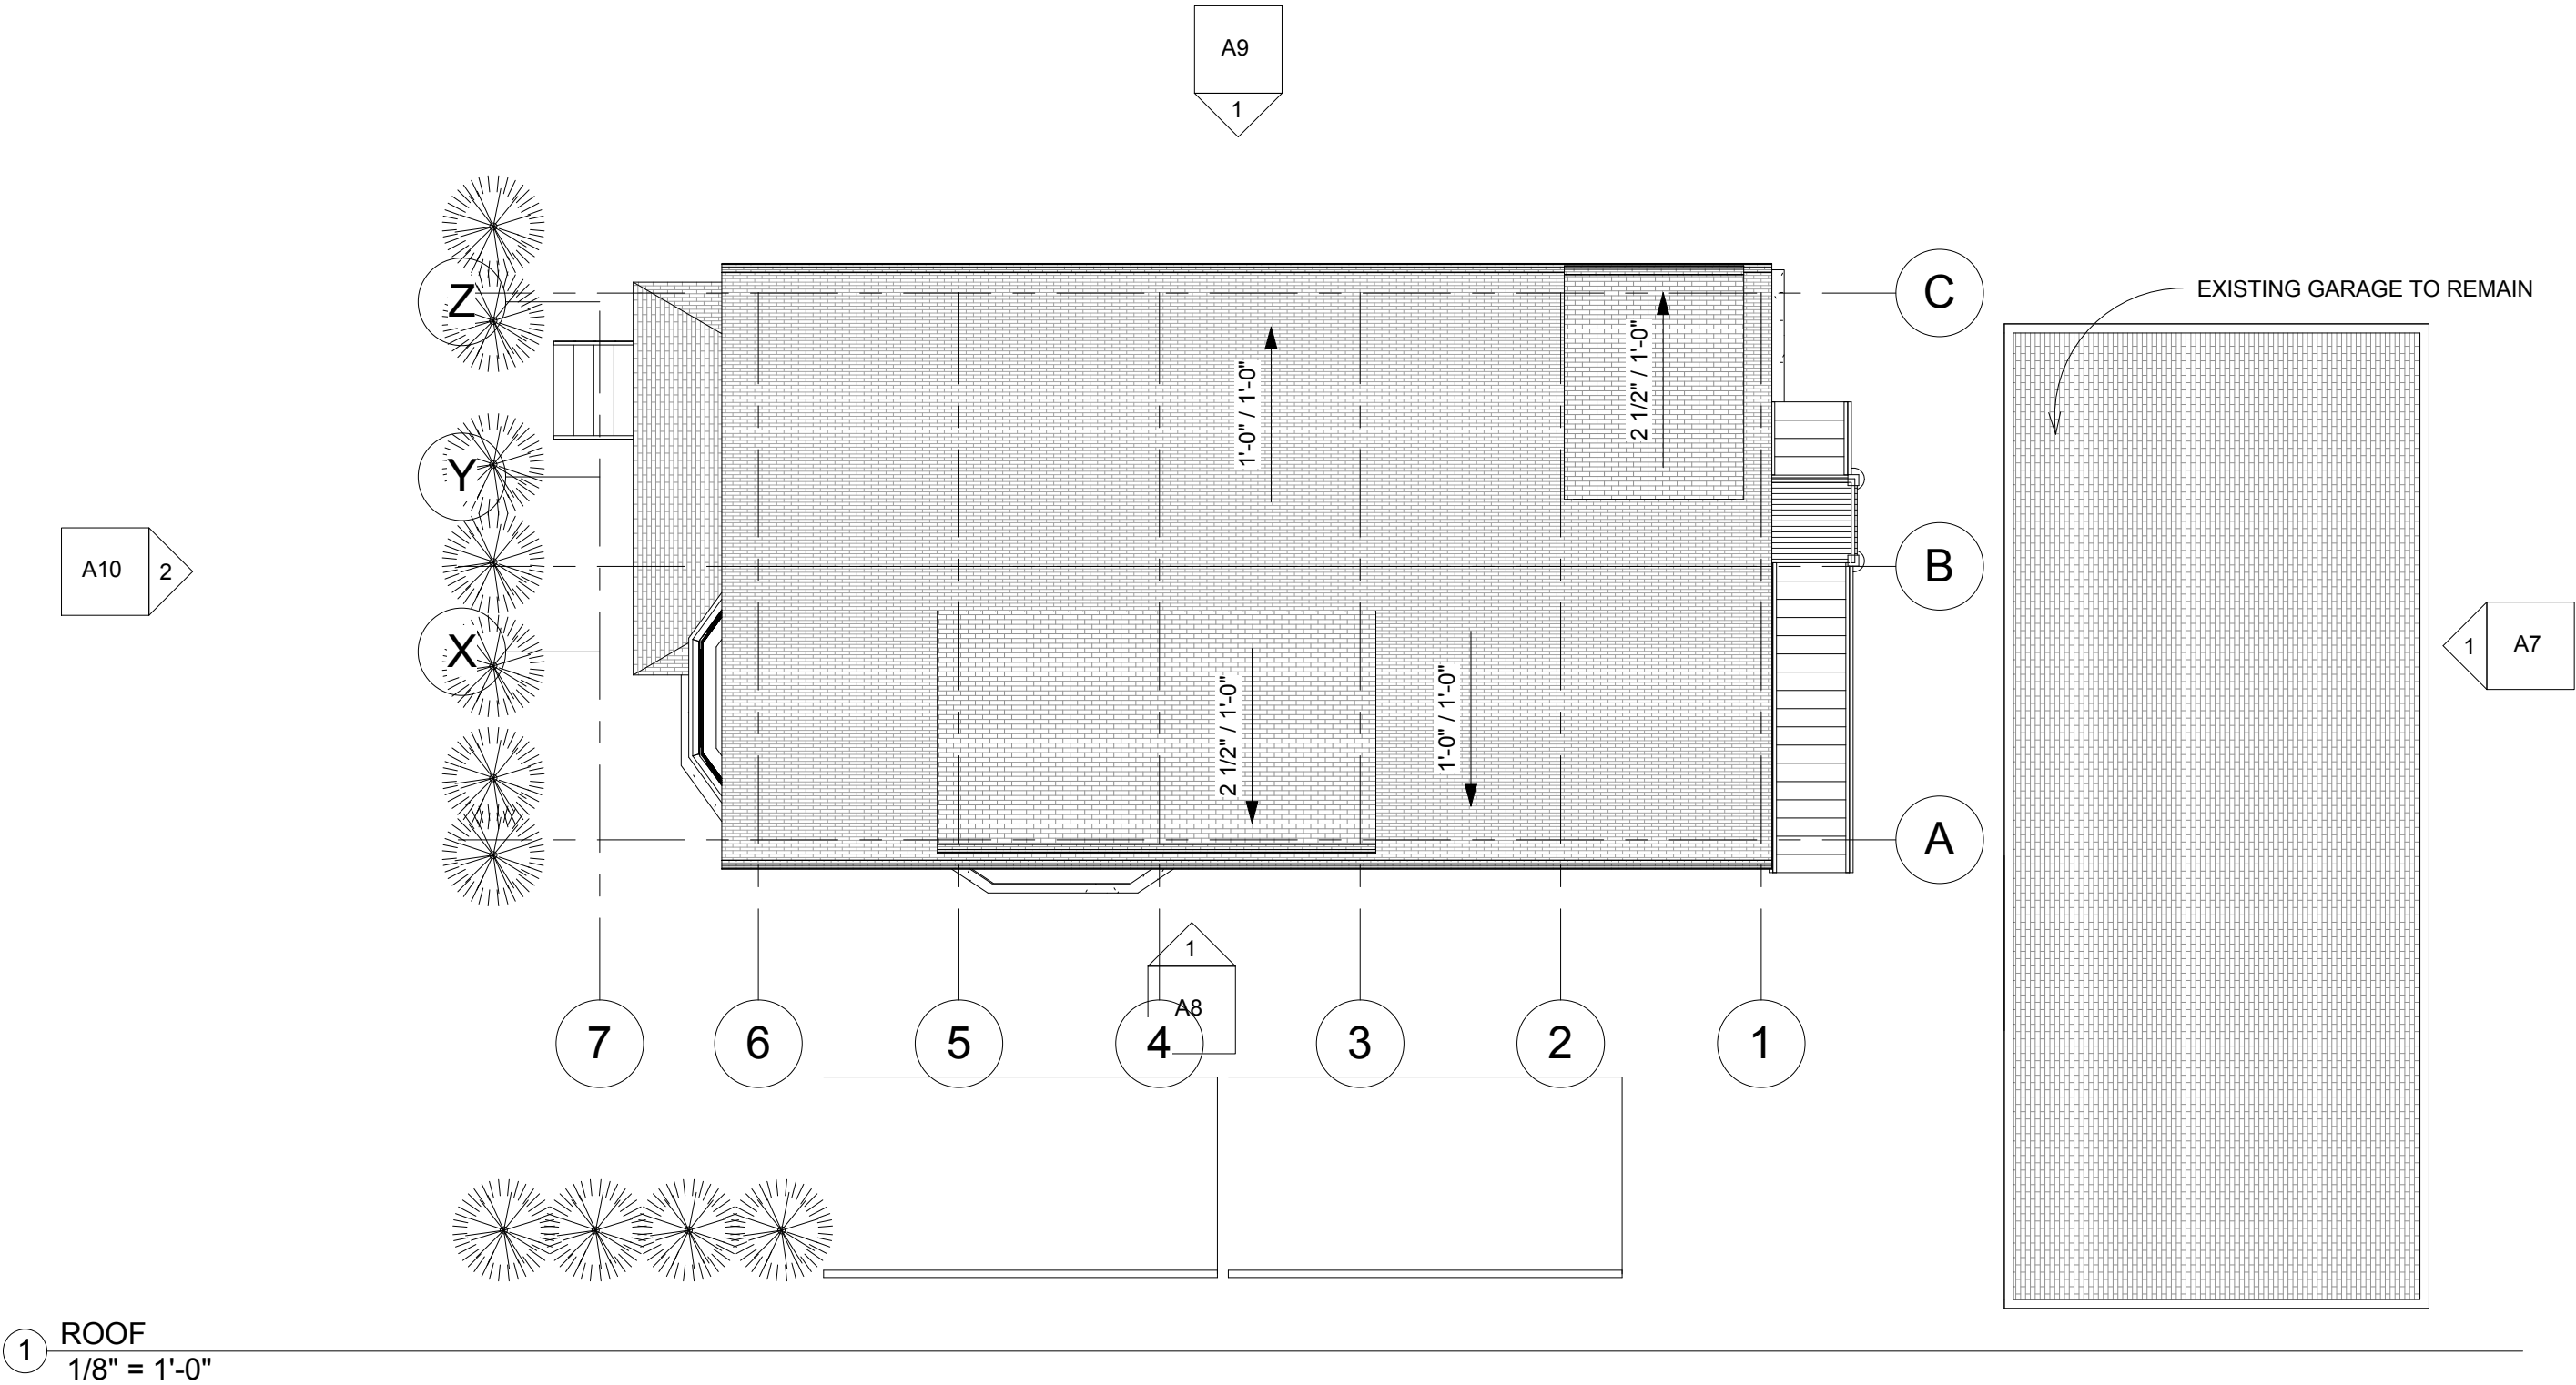
No.	Description	Date

ATTIC FLOOR FRAMING

Project number	Project Number
Date	Issue Date
Drawn by	Author
Checked by	Checker

A5.1
Scale 3/16" = 1'-0"

NOTES: VERIFY ALL DIMENSIONS IN FIELD PRIOR TO FABRICATION AND CONSTRUCTION. ALL EXISTING CONDITIONS TO REMAIN AS IS UNLESS OTHERWISE NOTED



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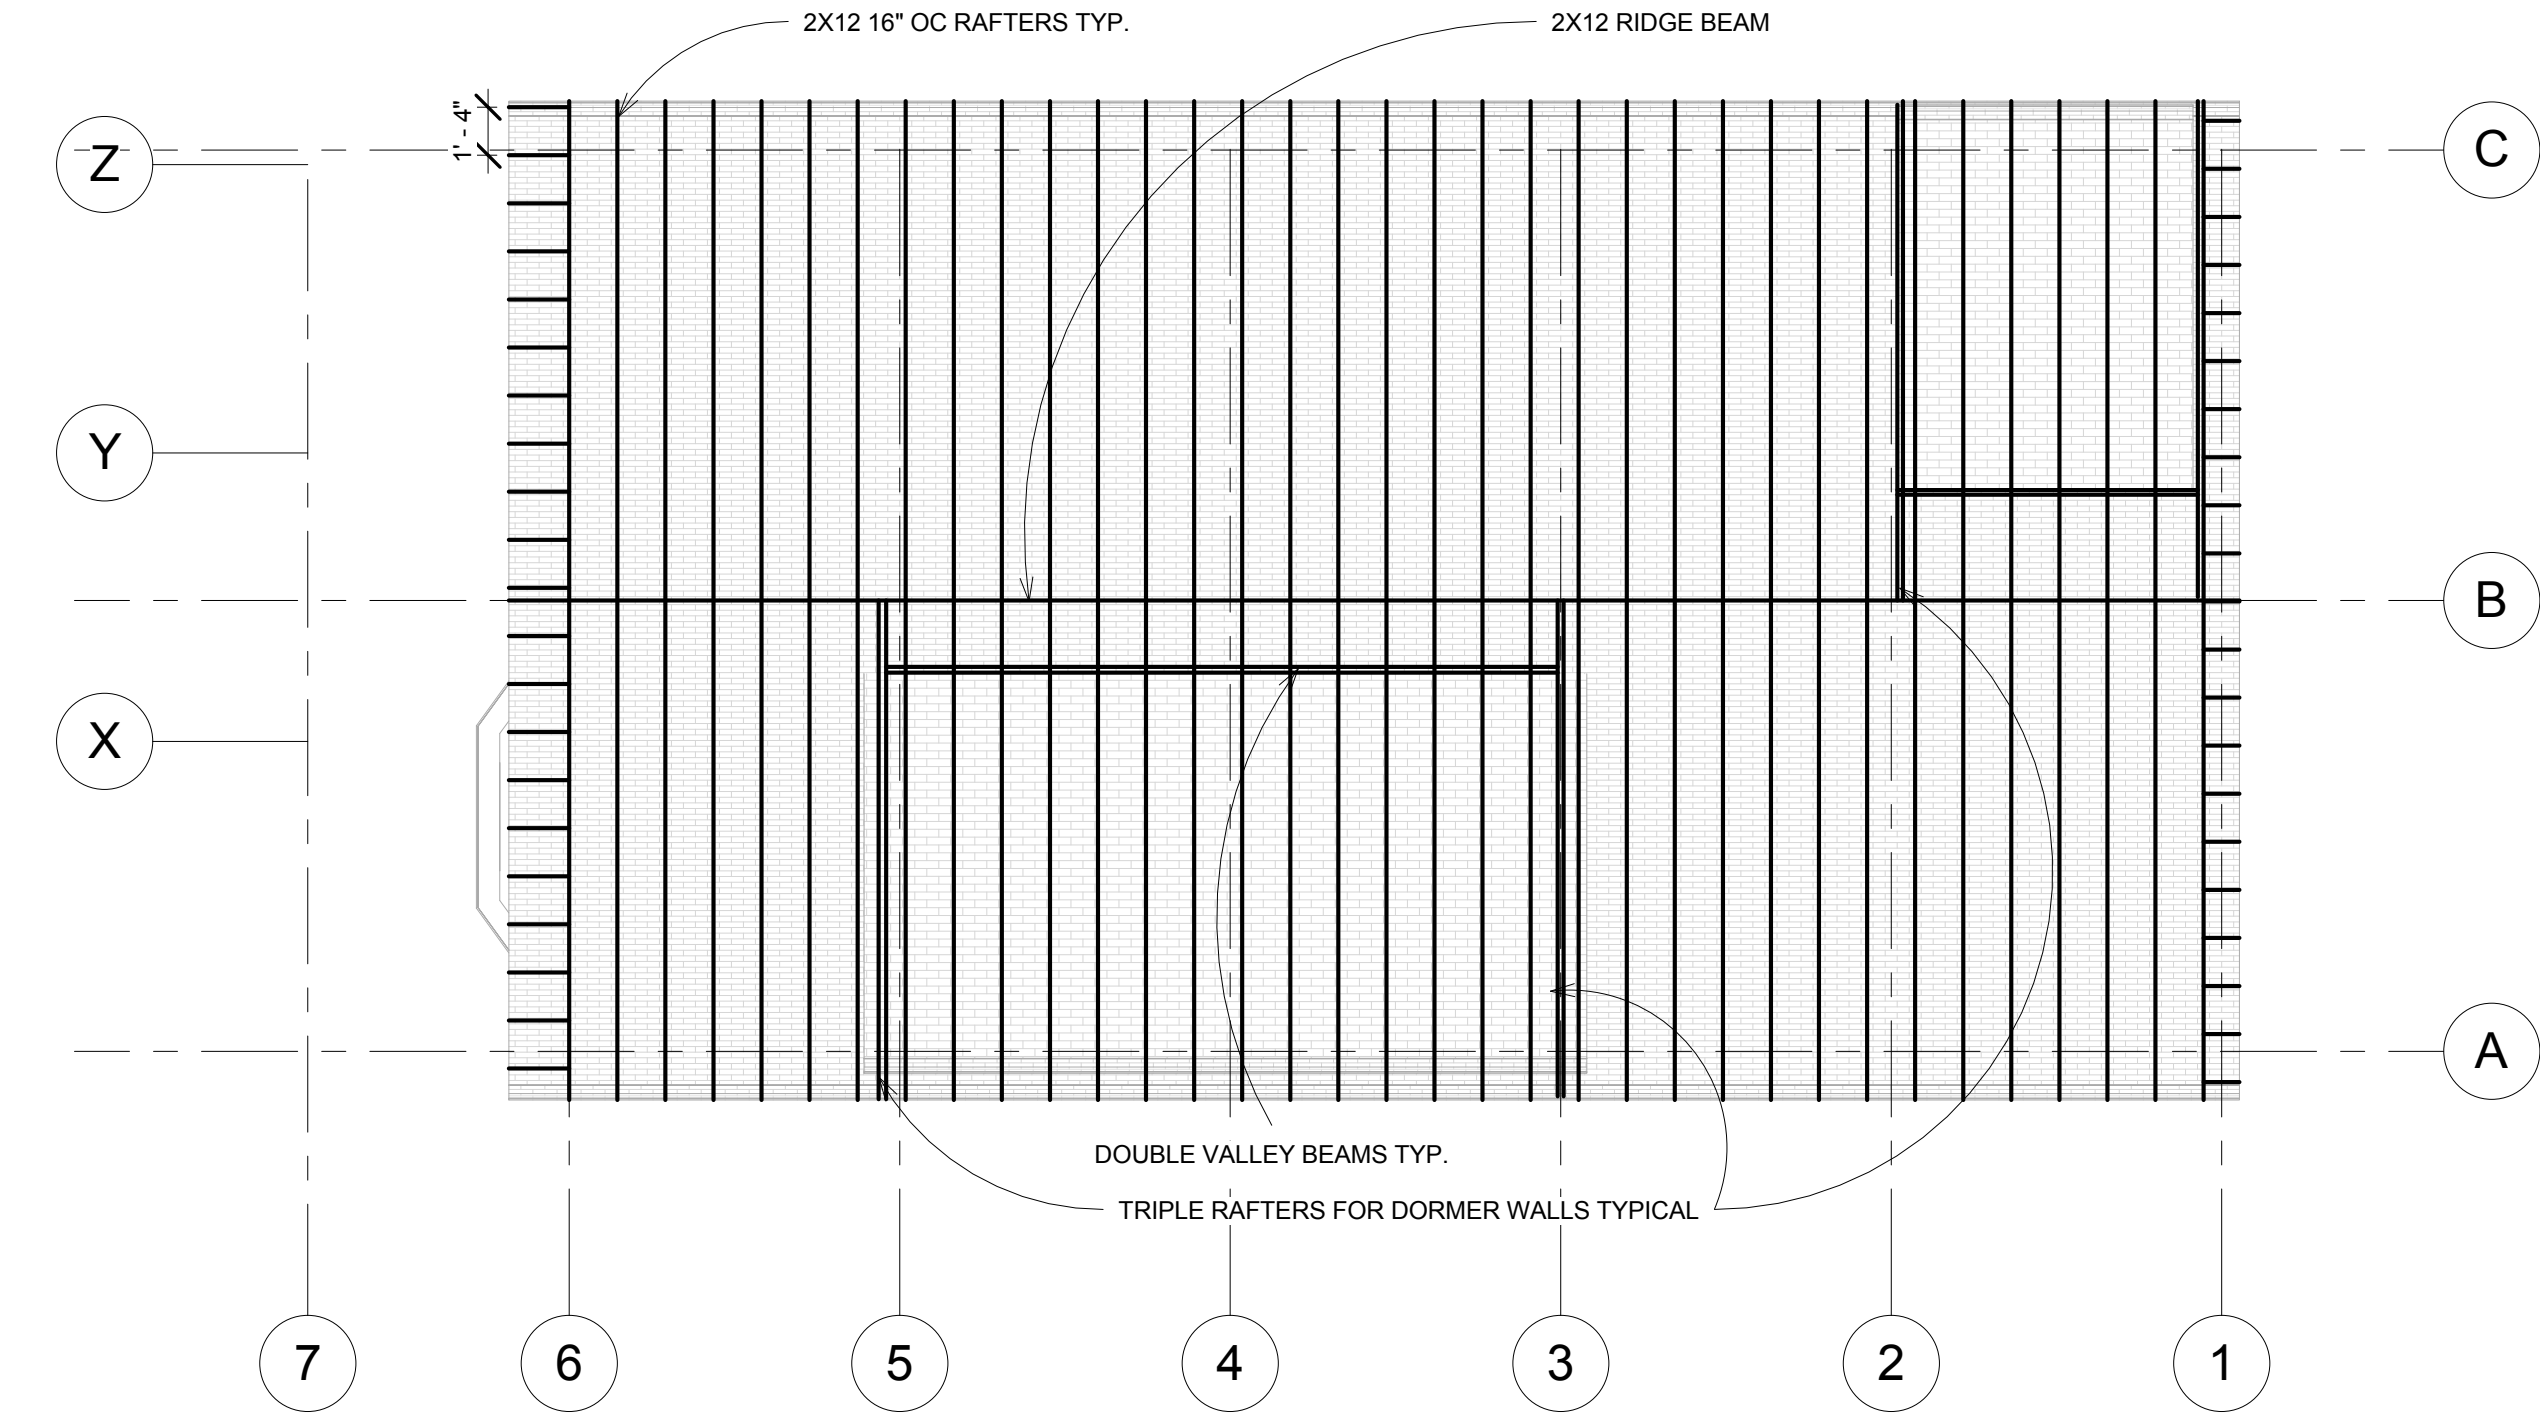
No.	Description	Date

ROOF

Project number	Project Number
Date	Issue Date
Drawn by	Author
Checked by	Checker

A6
Scale 1/8" = 1'-0"

NOTES: VERIFY ALL DIMENSIONS IN FIELD PRIOR TO FABRICATION AND CONSTRUCTION. ALL EXISTING CONDITIONS TO REMAIN AS IS UNLESS OTHERWISE NOTED



1 ROOF FRAMING
3/16" = 1'-0"



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No.	Description	Date


ROOF FRAMING

Project number	Project Number
Date	Issue Date
Drawn by	Author
Checked by	Checker


A6.1

Scale 3/16" = 1'-0"

NOTES: VERIFY ALL DIMENSIONS IN FIELD PRIOR TO FABRICATION AND CONSTRUCTION. ALL EXISTING CONDITIONS TO REMAIN AS IS UNLESS OTHERWISE NOTED

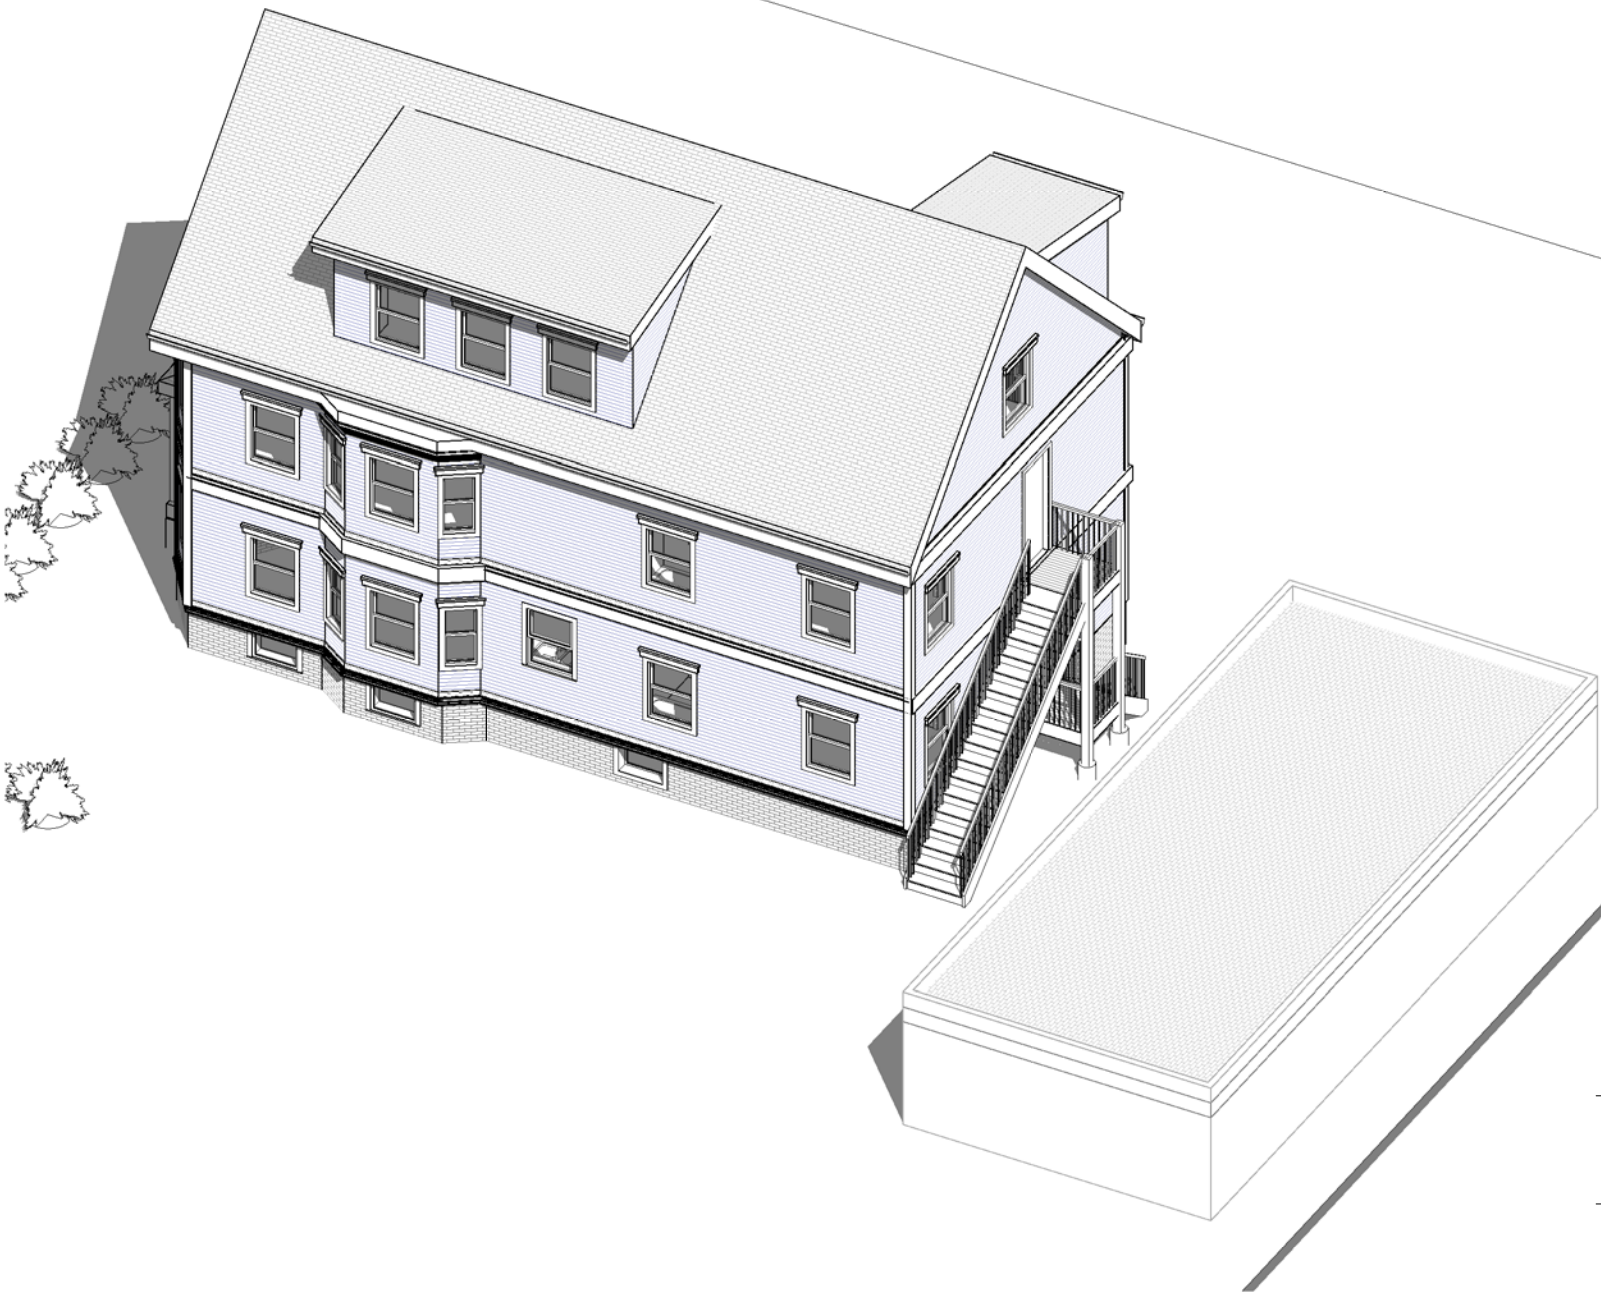

2 AXONOMETRIC VIEW2

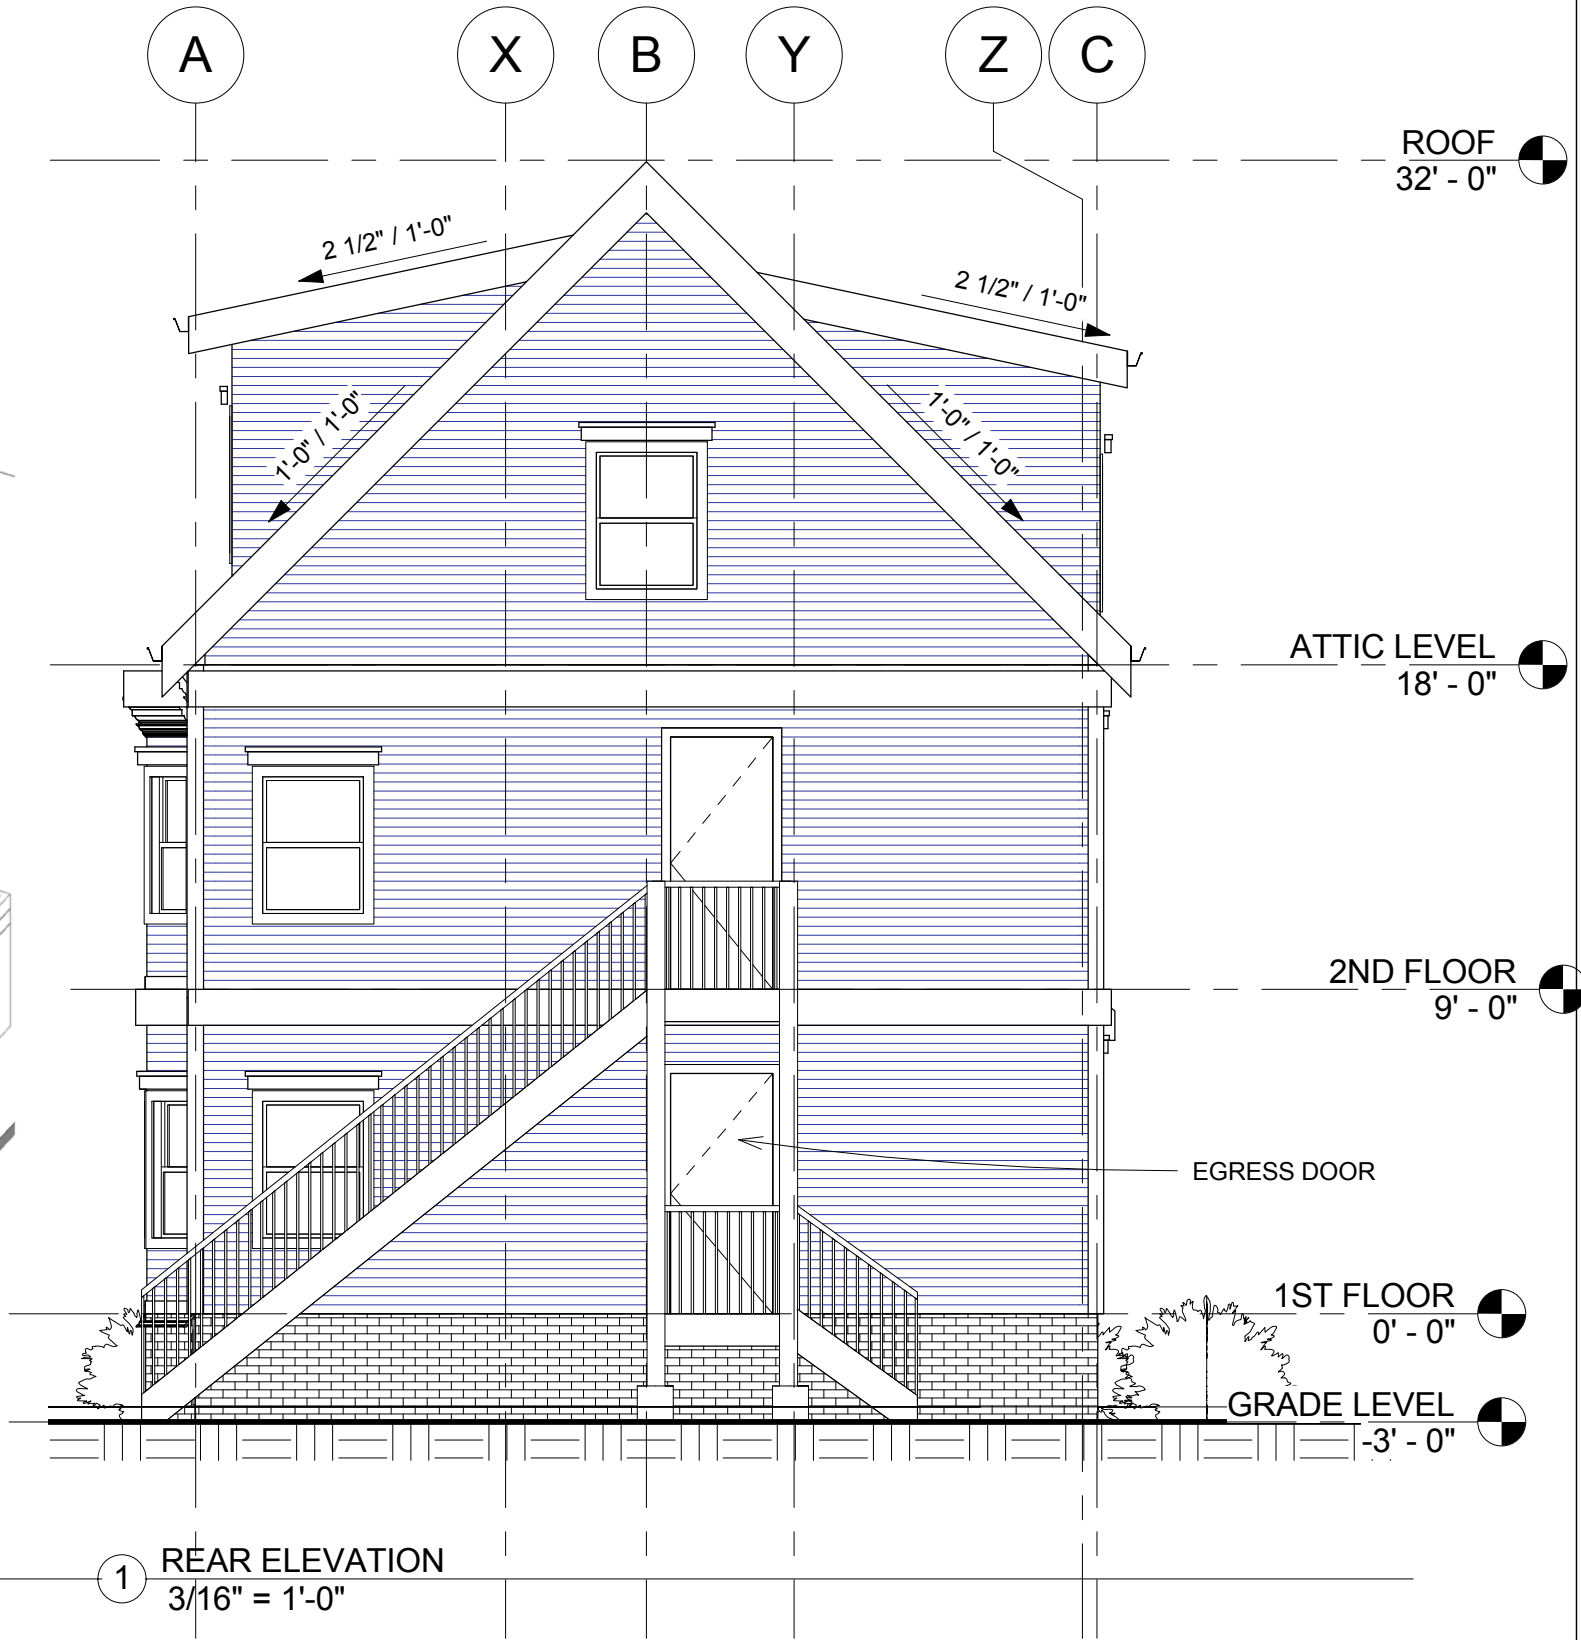

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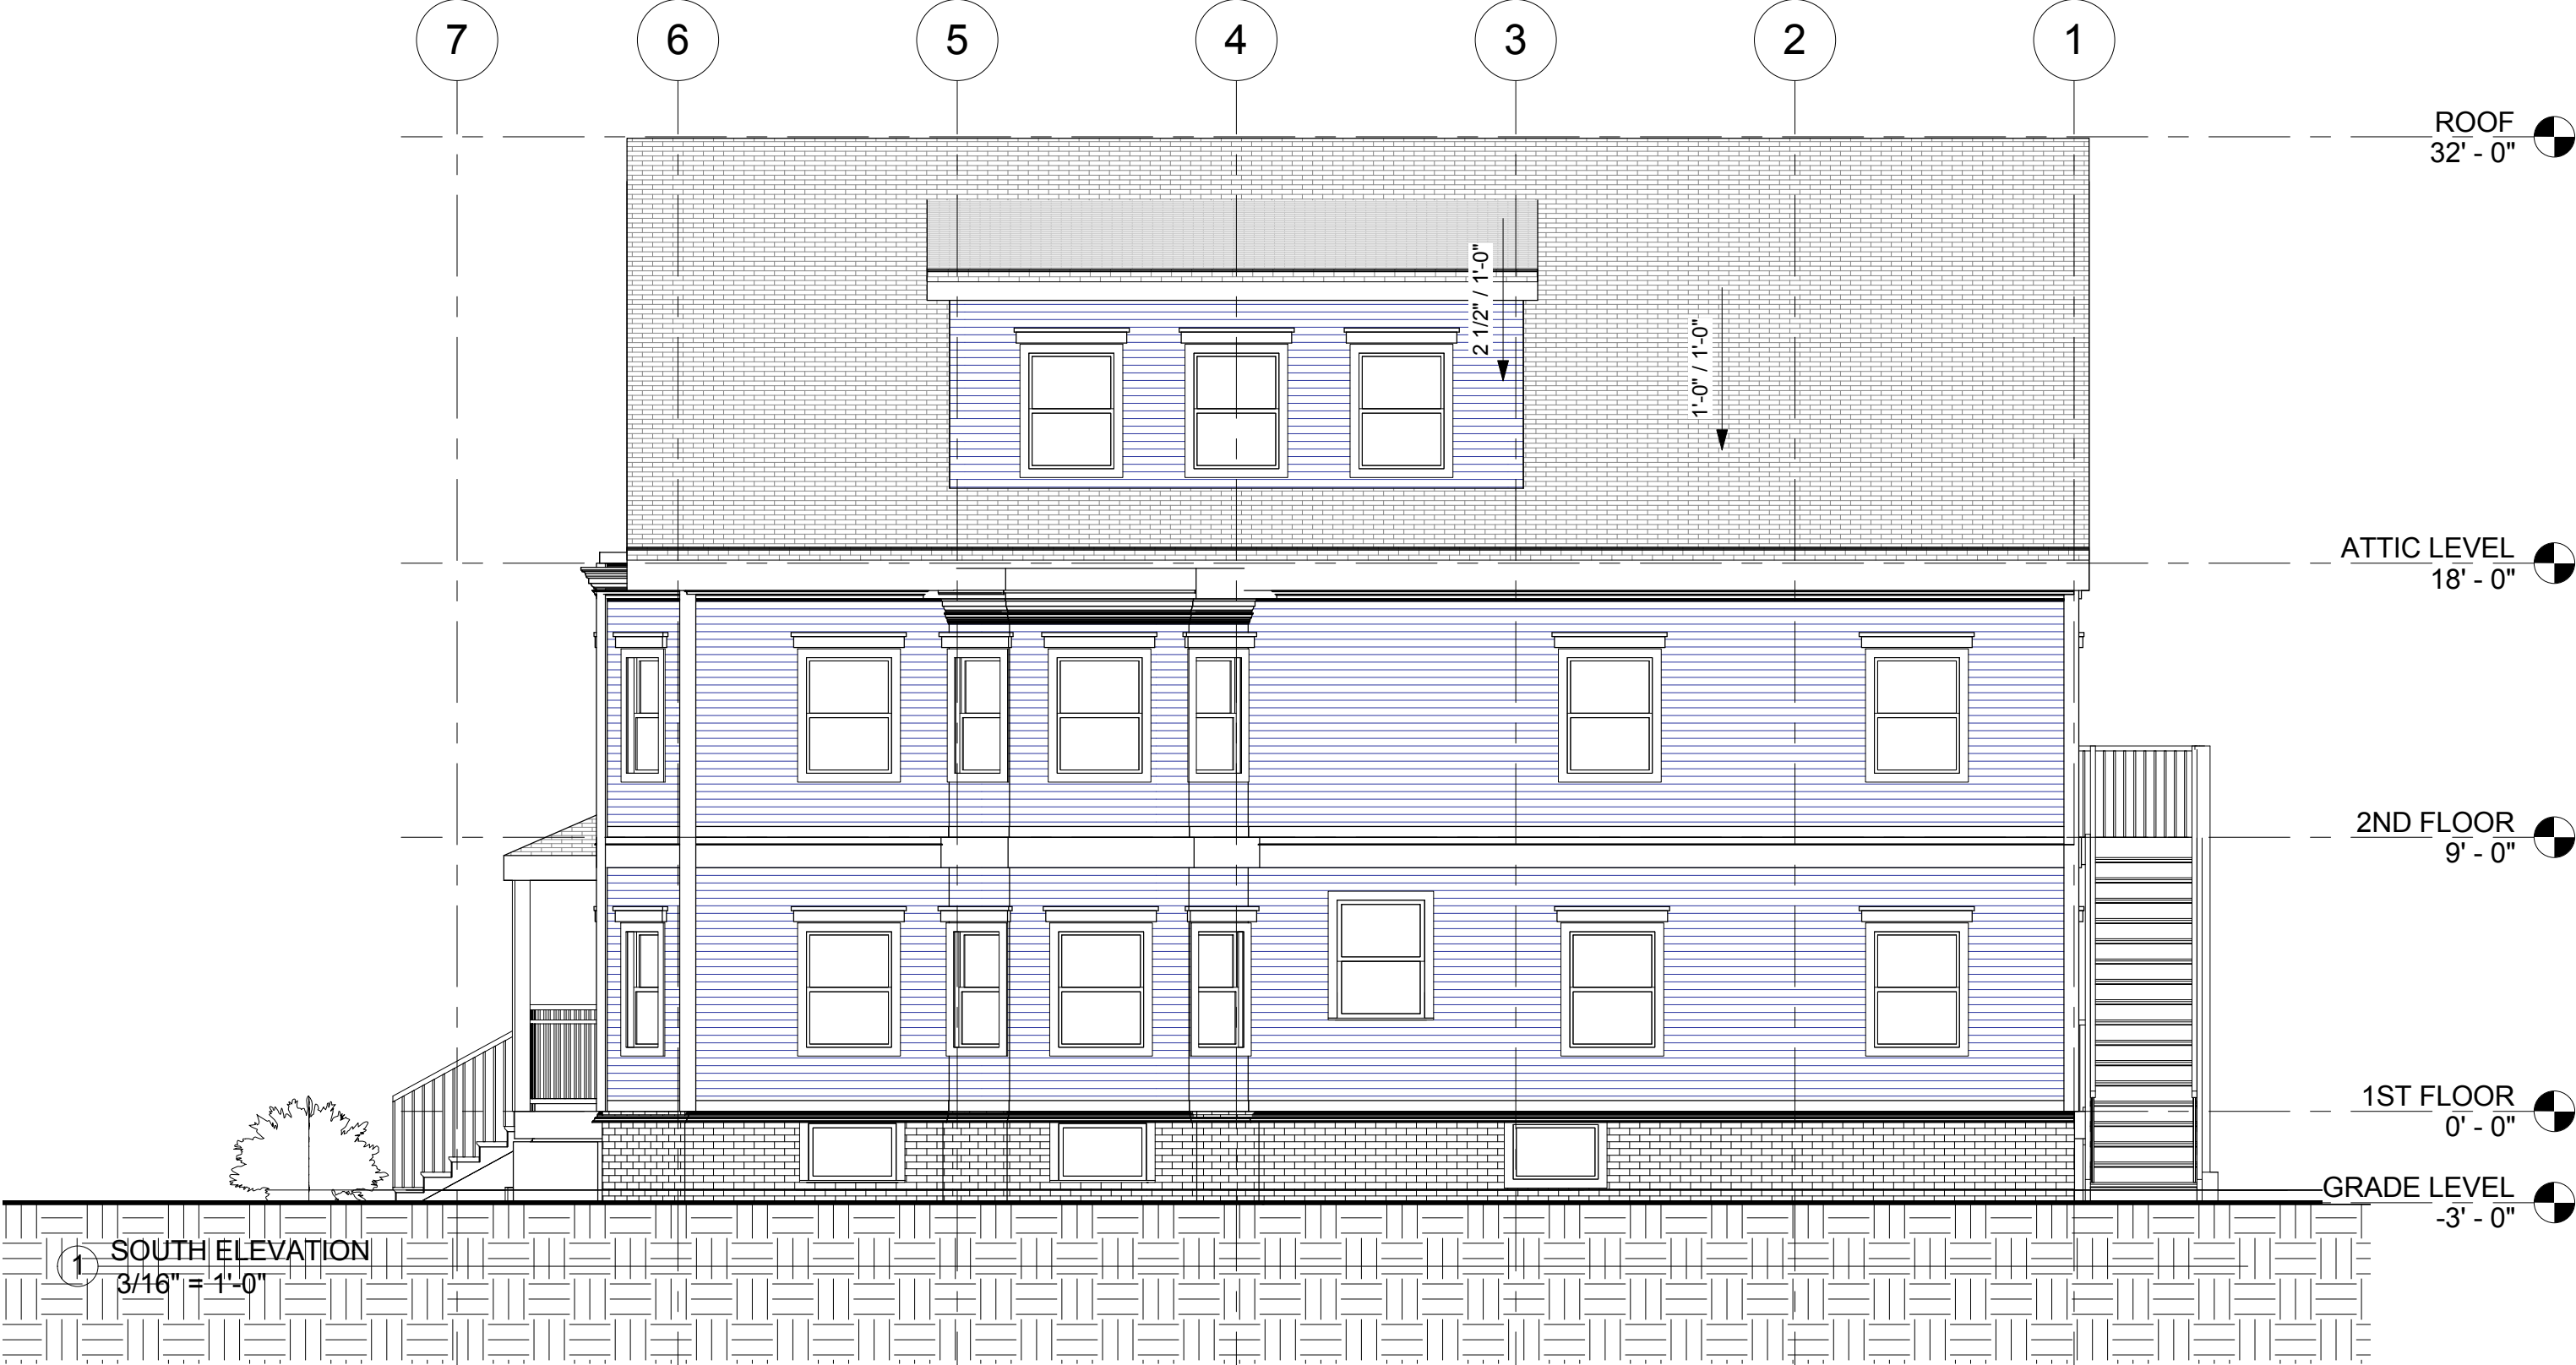
No.	Description	Date

ELEVATION

Project number	Project Number
Date	Issue Date
Drawn by	Author
Checked by	Checker

A7
Scale 3/16" = 1'-0"

NOTES: VERIFY ALL DIMENSIONS IN FIELD PRIOR TO FABRICATION AND CONSTRUCTION. ALL EXISTING CONDITIONS TO REMAIN AS IS UNLESS OTHERWISE NOTED



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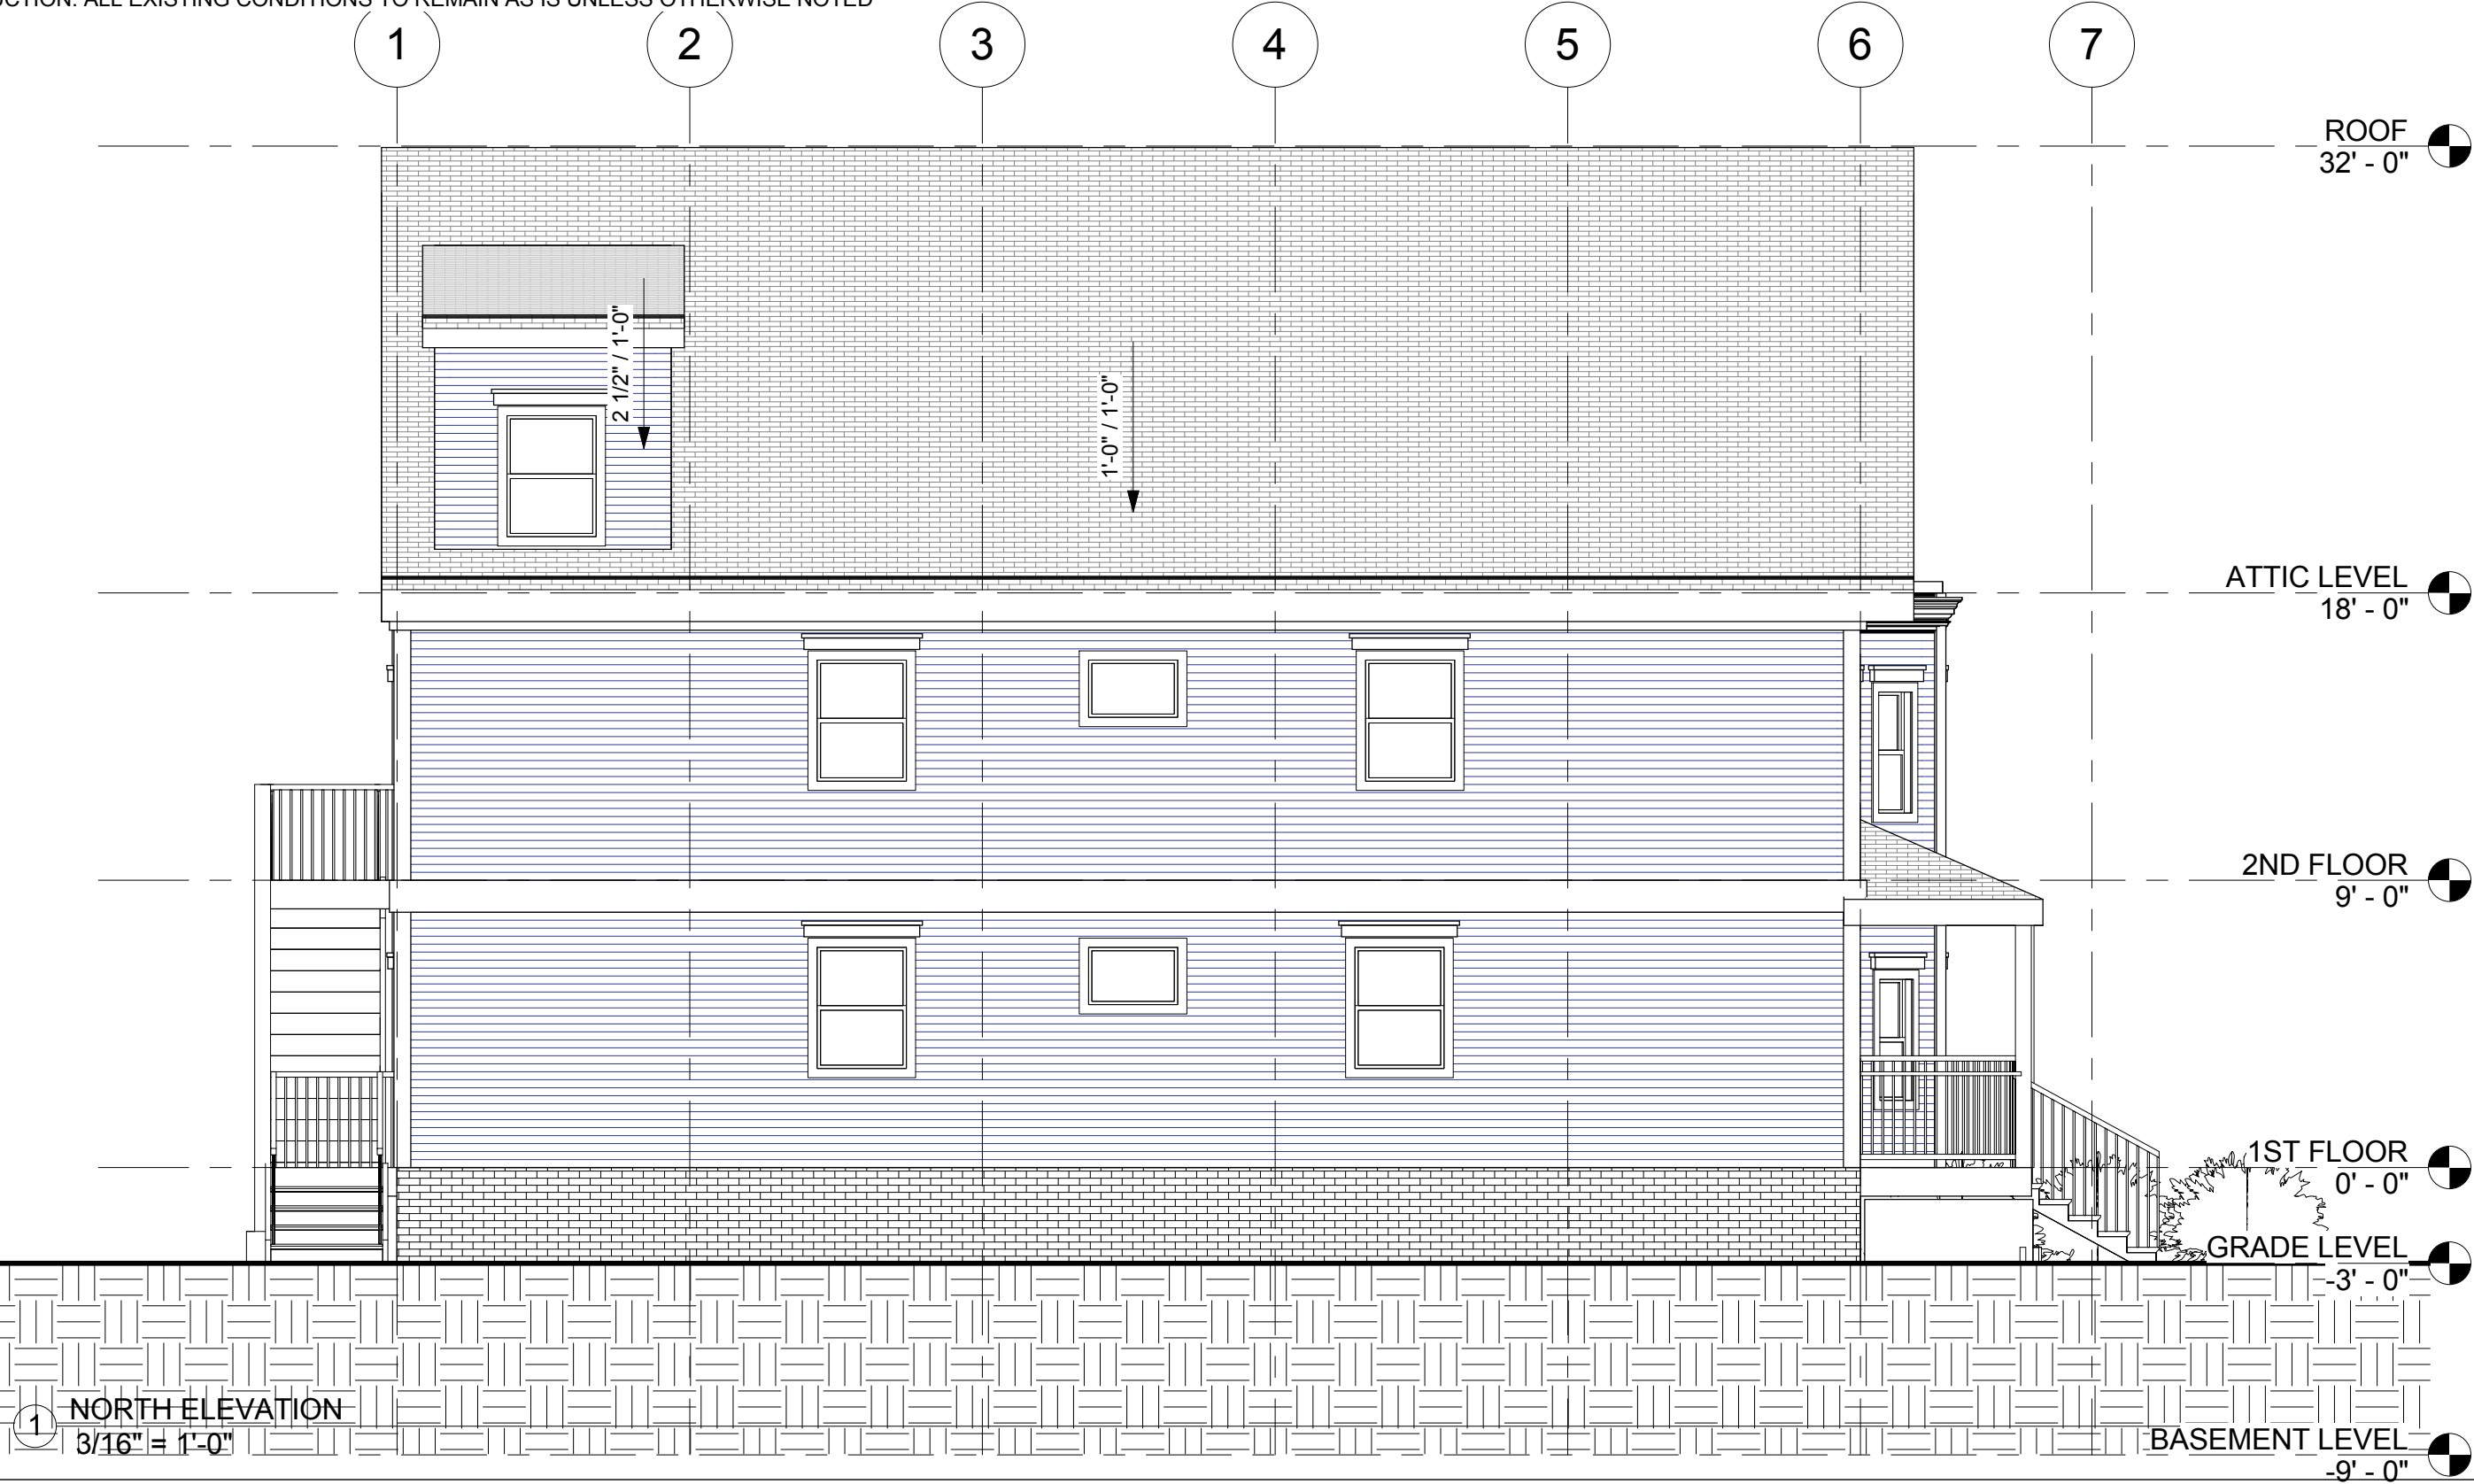
No.	Description	Date

ELEVATION

Project number	Project Number
Date	Issue Date
Drawn by	Author
Checked by	Checker

A8
Scale 3/16" = 1'-0"

NOTES: VERIFY ALL DIMENSIONS IN FIELD PRIOR TO FABRICATION AND CONSTRUCTION. ALL EXISTING CONDITIONS TO REMAIN AS IS UNLESS OTHERWISE NOTED



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No.	Description	Date


ELEVATION

Project number	Project Number
Date	Issue Date
Drawn by	Author
Checked by	Checker

A9

Scale 3/16" = 1'-0"

NOTES: VERIFY ALL DIMENSIONS IN FIELD PRIOR TO FABRICATION AND CONSTRUCTION. ALL EXISTING CONDITIONS TO REMAIN AS IS UNLESS OTHERWISE NOTED

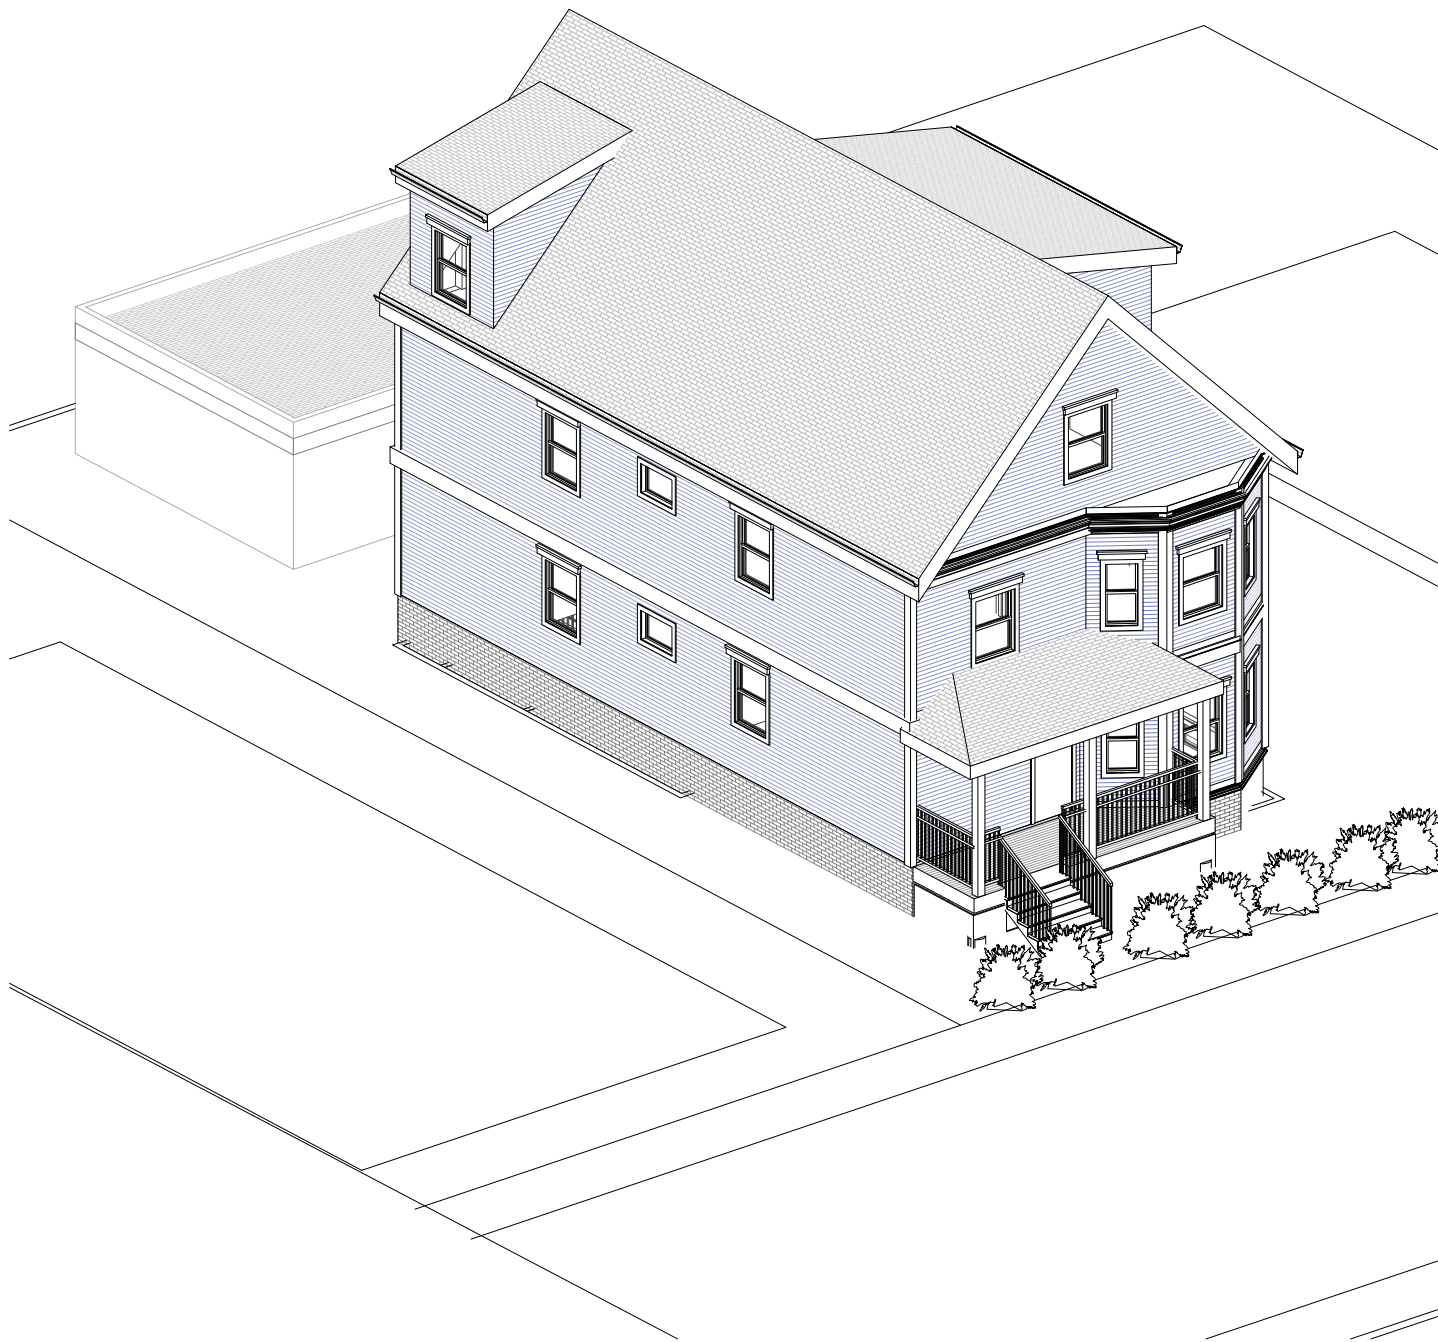

1 AXONOMETRIC VIEW1



2 WEST ELEVATION
3/16" = 1'-0"



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TRIPLE DECKER REVIVAL

No.	Description	Date

ELEVATION

Project number	Project Number
Date	Issue Date
Drawn by	Author
Checked by	Checker

A10

Scale 3/16" = 1'-0"

NOTES: VERIFY ALL DIMENSIONS IN FIELD PRIOR TO FABRICATION AND CONSTRUCTION. ALL EXISTING CONDITIONS TO REMAIN AS IS UNLESS OTHERWISE NOTED

Window Schedule			
Level	Type Mark	Family and Type	Comments

BASEMENT LEVEL	C	Fixed with Trim: 36" x 24"	ENERGY STAR
BASEMENT LEVEL	C	Fixed with Trim: 36" x 24"	ENERGY STAR
BASEMENT LEVEL	C	Fixed with Trim: 36" x 24"	ENERGY STAR
1ST FLOOR	A	Double Hung with Trim: 36" x 48"	ENERGY STAR
1ST FLOOR	A	Double Hung with Trim: 36" x 48"	ENERGY STAR
1ST FLOOR	B	Double Hung with Trim: 24" x 48"	ENERGY STAR
1ST FLOOR	B	Double Hung with Trim: 24" x 48"	ENERGY STAR
1ST FLOOR	B	Double Hung with Trim: 24" x 48"	ENERGY STAR
1ST FLOOR	B	Double Hung with Trim: 24" x 48"	ENERGY STAR
1ST FLOOR	C	Fixed with Trim: 36" x 24"	ENERGY STAR
1ST FLOOR	D	Fixed with Trim: 24" x 24"	ENERGY STAR
2ND FLOOR	A	Double Hung with Trim: 36" x 48"	ENERGY STAR
2ND FLOOR	A	Double Hung with Trim: 36" x 48"	ENERGY STAR
2ND FLOOR	B	Double Hung with Trim: 24" x 48"	ENERGY STAR
2ND FLOOR	B	Double Hung with Trim: 24" x 48"	ENERGY STAR
2ND FLOOR	B	Double Hung with Trim: 24" x 48"	ENERGY STAR
2ND FLOOR	B	Double Hung with Trim: 24" x 48"	ENERGY STAR
2ND FLOOR	B	Double Hung with Trim: 24" x 48"	ENERGY STAR
2ND FLOOR	C	Fixed with Trim: 36" x 24"	ENERGY STAR
ATTIC LEVEL	A	Double Hung with Trim: 36" x 48"	ENERGY STAR
ATTIC LEVEL	A	Double Hung with Trim: 36" x 48"	ENERGY STAR
ATTIC LEVEL	A	Double Hung with Trim: 36" x 48"	ENERGY STAR
ATTIC LEVEL	A	Double Hung with Trim: 36" x 48"	ENERGY STAR
ATTIC LEVEL	A	Double Hung with Trim: 36" x 48"	ENERGY STAR
ATTIC LEVEL	A	Double Hung with Trim: 36" x 48"	ENERGY STAR



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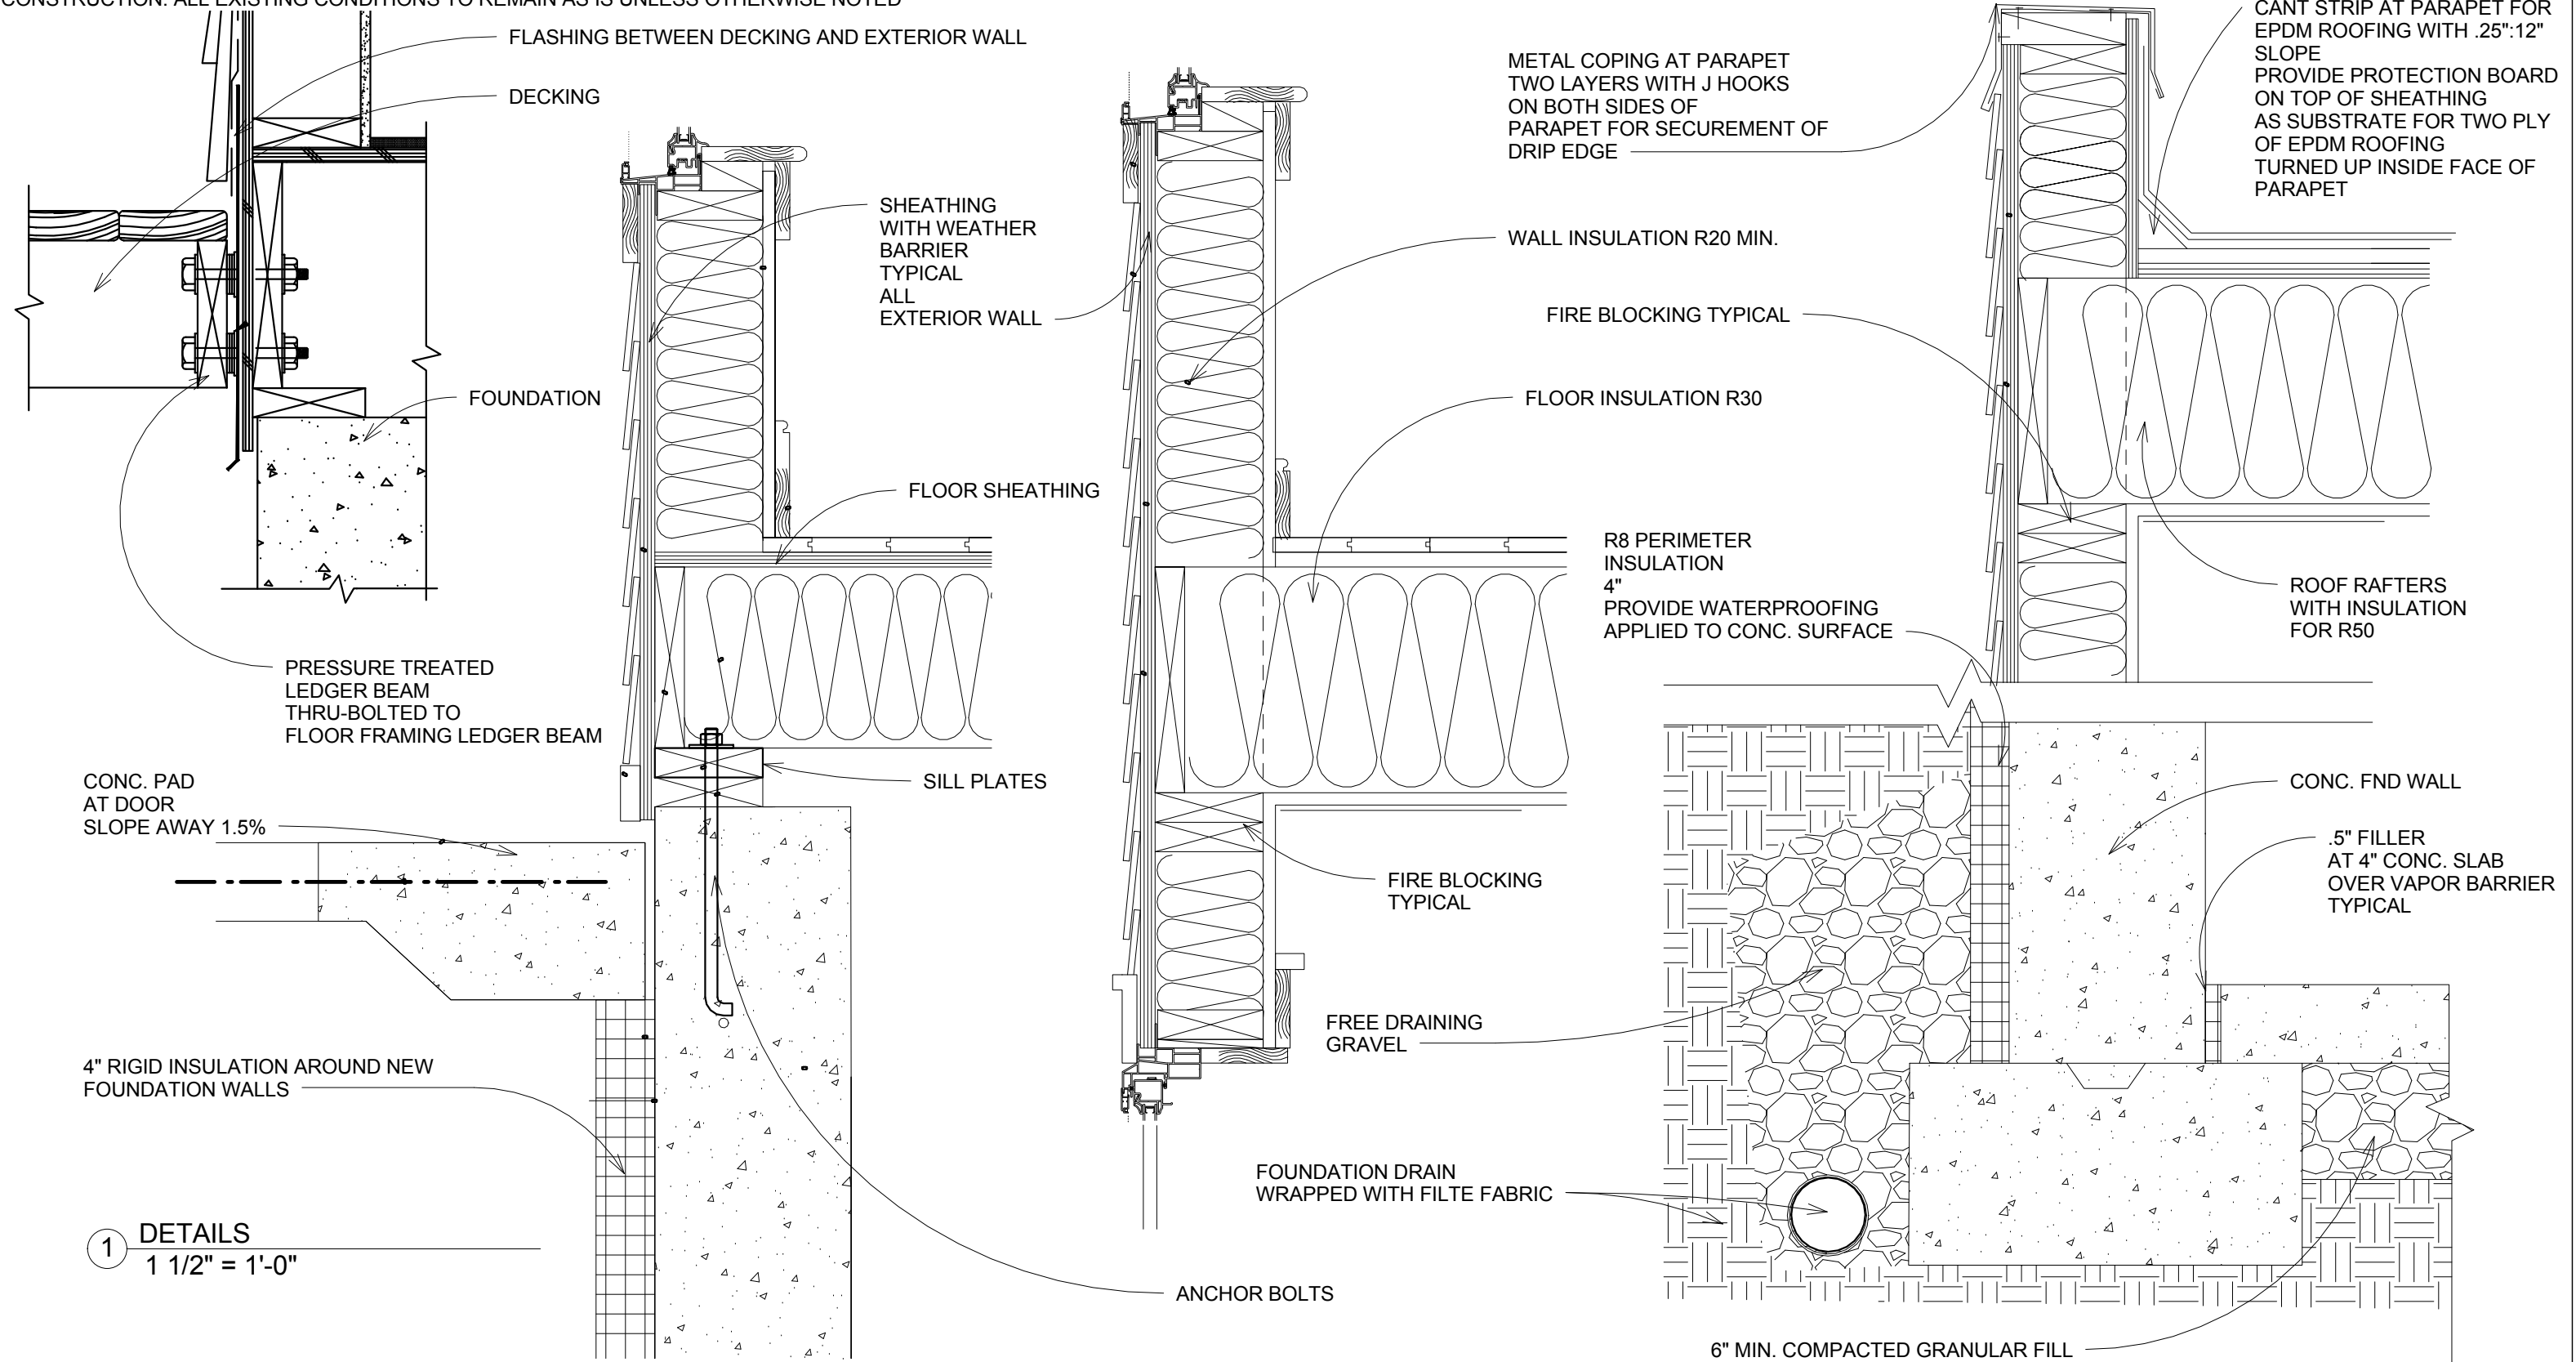
30 FRANKLIN STREET,
SOMERVILLE, MA
TRIPLE DECKER REVIVAL

No.	Description	Date

SCHEDULES

Project number	Project Number	A11
Date	Issue Date	
Drawn by	Author	
Checked by	Checker	Scale

NOTES: VERIFY ALL DIMENSIONS IN FIELD PRIOR TO FABRICATION AND CONSTRUCTION. ALL EXISTING CONDITIONS TO REMAIN AS IS UNLESS OTHERWISE NOTED



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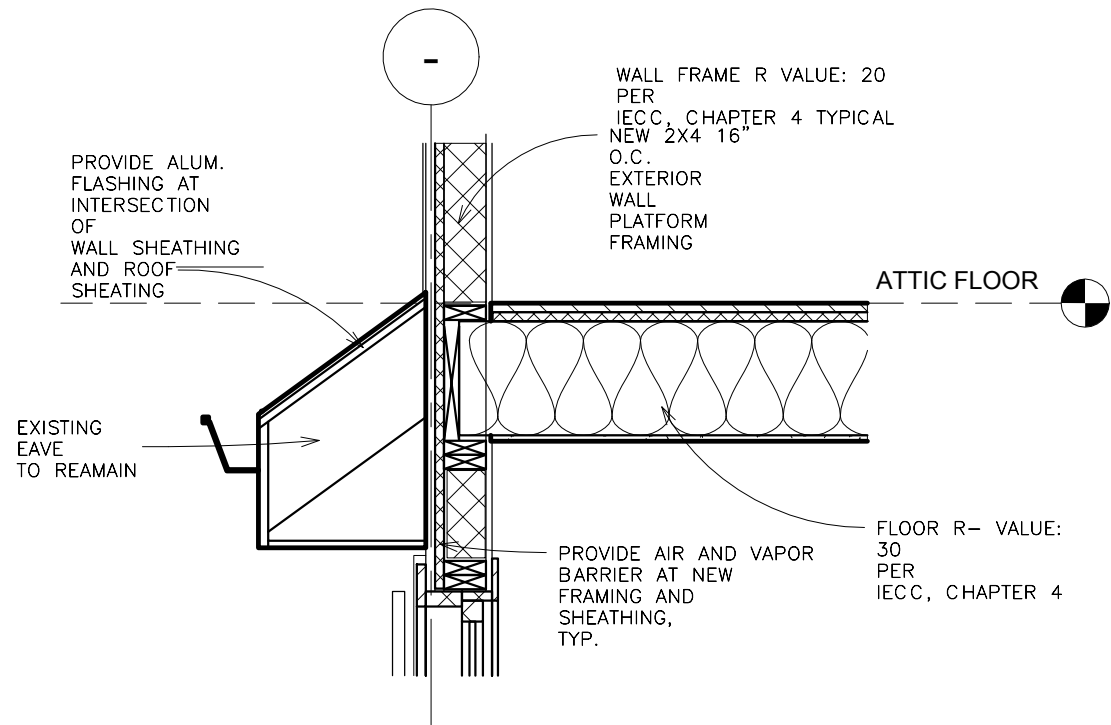
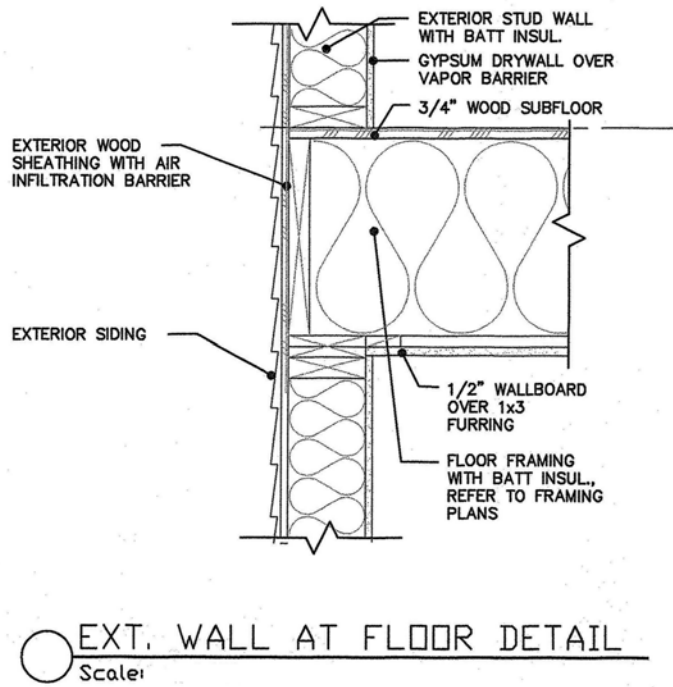
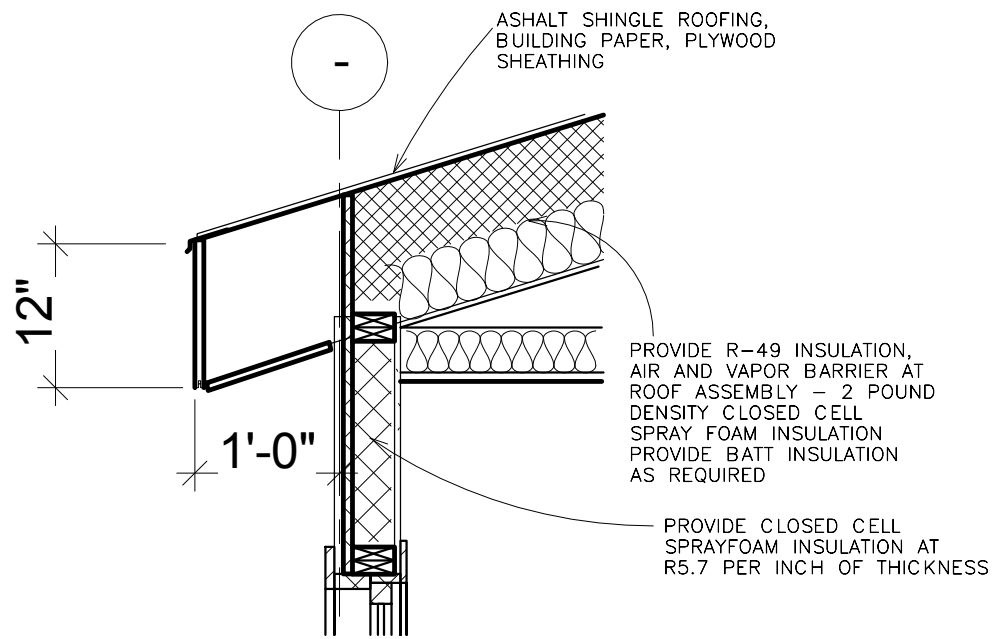
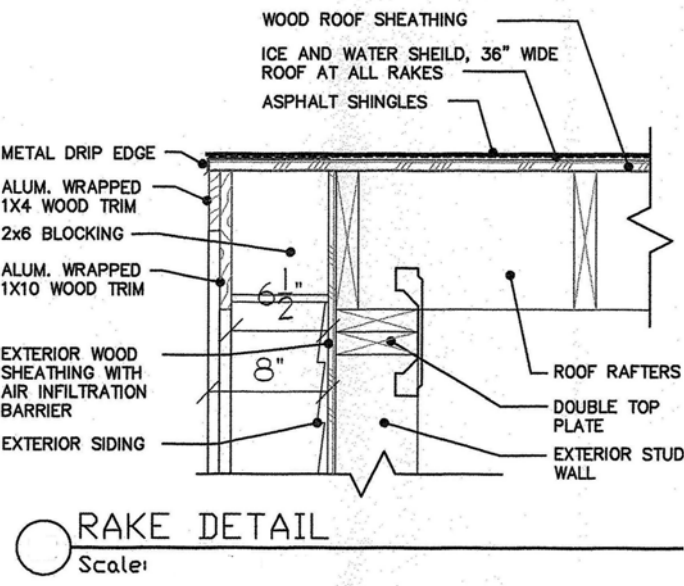
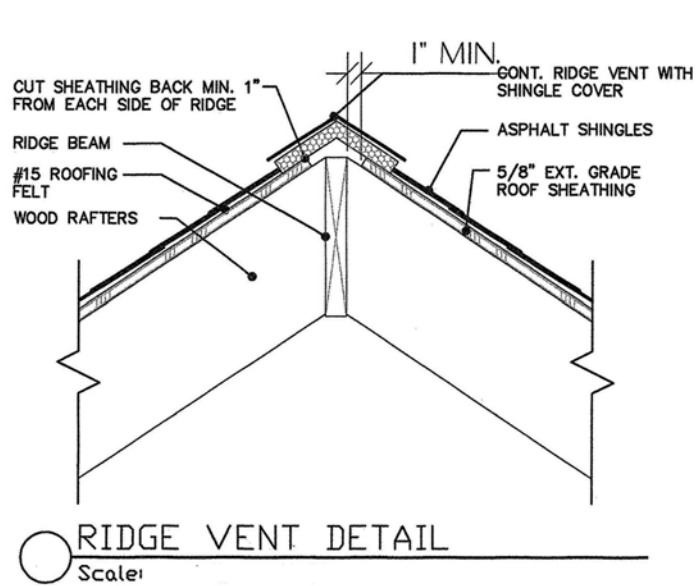
No.	Description	Date

DETAILS 1 OF 2

Project number	Project Number
Date	Issue Date
Drawn by	Author
Checked by	Checker

A12
Scale 1 1/2" = 1'-0"

NOTES: VERIFY ALL DIMENSIONS IN FIELD PRIOR TO FABRICATION AND CONSTRUCTION. ALL EXISTING CONDITIONS TO REMAIN AS IS UNLESS OTHERWISE NOTED



1 DORMER DETAILS
3/4" = 1'-0"



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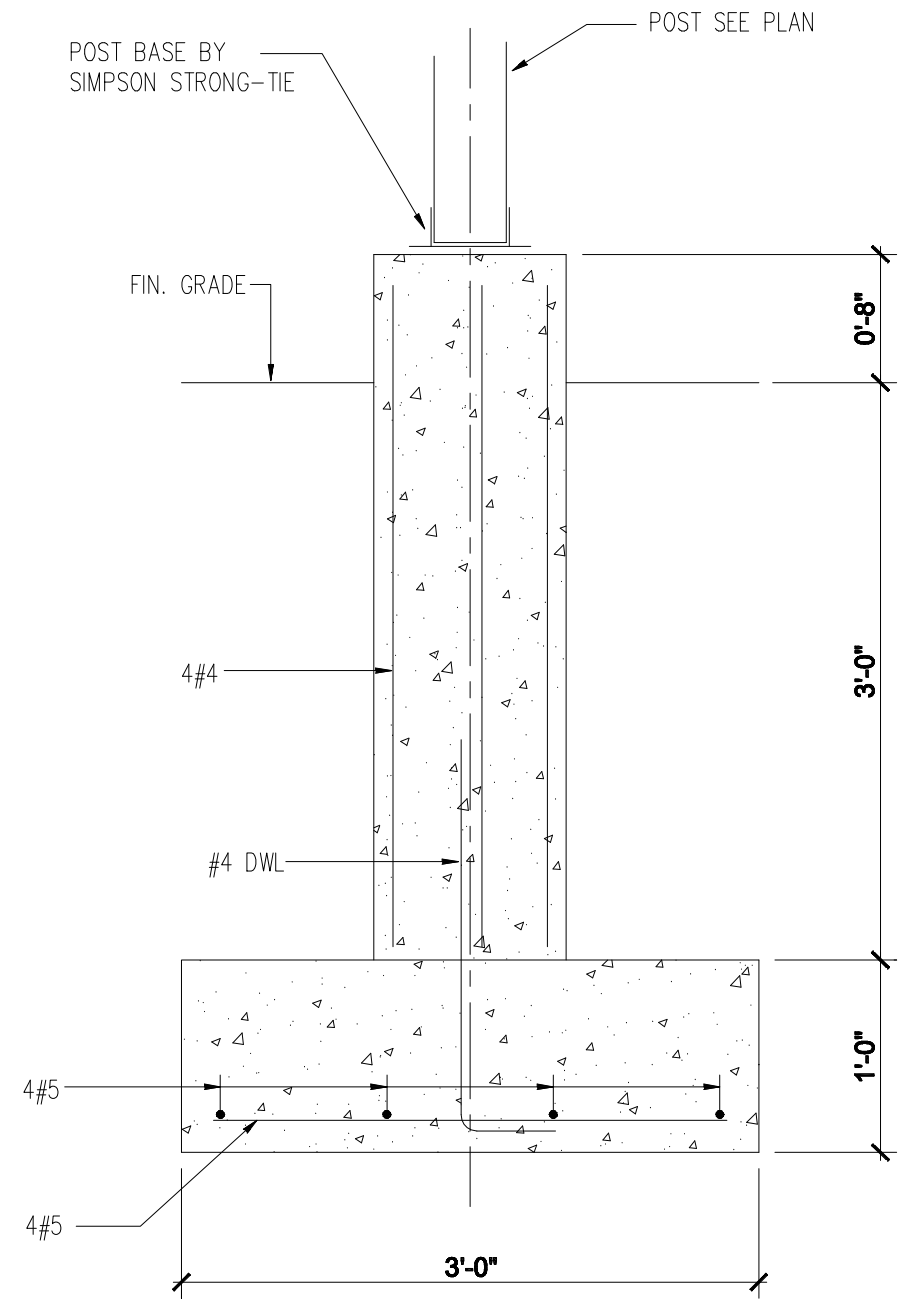
30 FRANKLIN STREET,
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TRIPLE DECKER REVIVAL

No.	Description	Date



DETAILS 2 OF 2

Project number	Project Number	A13
Date	Issue Date	
Drawn by	Author	
Checked by	Checker	
Scale 3/4" = 1'-0"		


NOTES: VERIFY ALL DIMENSIONS IN FIELD PRIOR TO FABRICATION AND CONSTRUCTION. ALL EXISTING CONDITIONS TO REMAIN AS IS UNLESS OTHERWISE NOTED



1 DECK DETAILS
1" = 1'-0"

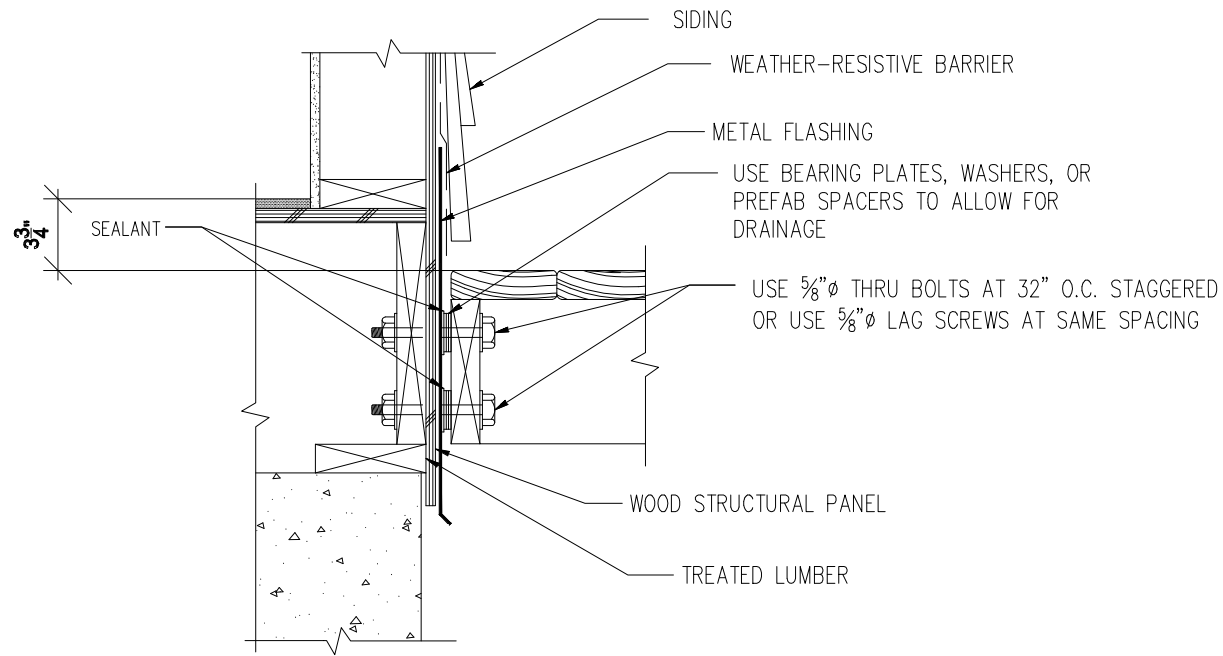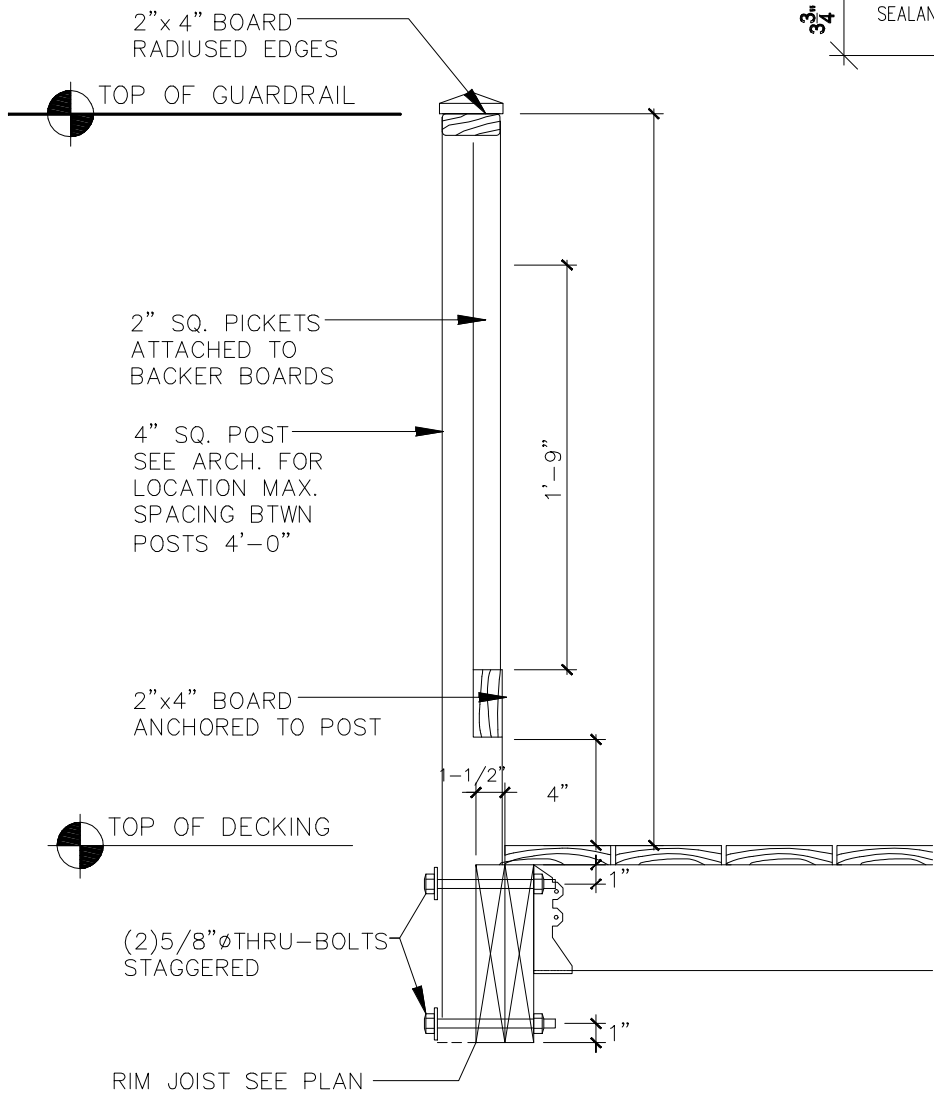

ALL STAIR COMPONENTS TO MEET CODE DIMENSIONAL REQUIREMENTS

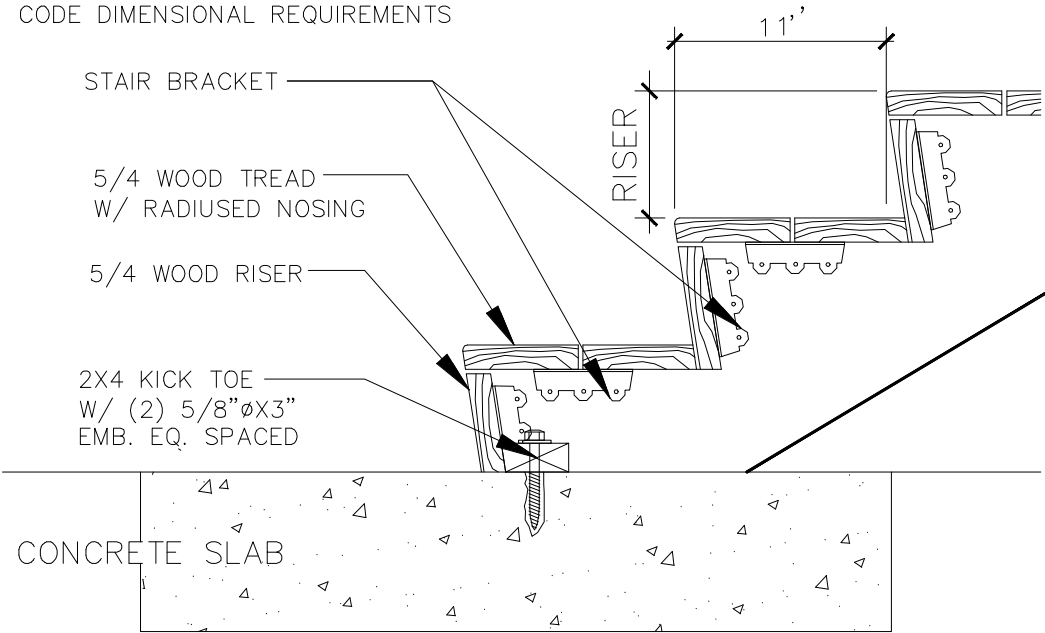

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No.	Description	Date

DECK DETAILS

Project number	Project Number
Date	Issue Date
Drawn by	Author
Checked by	Checker

A14

Scale 1" = 1'-0"